

DESCRIPTION	UNITS
PROPERTY GROSS TARE	729.56 SQ. FT.
GROUND FLOOR AREA	476.53 SQ. FT.
2ND FLOOR AREA	476.53 SQ. FT.
ATTIC AREA	476.53 SQ. FT.
TOTAL AREA UNDER ROOF	1,429.59 SQ. FT.
TOTAL LIVING AREA	953.06 SQ. FT.
PATIO AREA	150 SQ. FT.
PATIO WALL HEIGHT	6' - 0 "
PATIO DIMENSIONS	9' -0" X 16'-8"
2ND FLOOR BALCONY AREA	67.36 SQ. FT.
BASEMENT AREA	N/A
BUILDING PERIMETER	93' - 6"
BUILDING HEIGHT	31' - 10"
ROOF PITCH	1% (1/4" PER 1'-0")
EGRESS CAPACITY	72" 50%F / 50% R
ZONING CLASSIFICATION	RSA-5
OCCUPANCY USAGE	SINGLE RESIDENCE
EXT. SURFACE AREA OF LIVING SPACE	1,992 SQ. FT.
GLAZED SURFACE AREA	148 SQ. FT.
PERCENTAGE GLAZED SURFACE AREA	7.4%
WALL INSULATION	R-19 BATT
CEILING INSULATION	R-38 BATT + RIGID
FOUNDATION INSULATION	R-10 RIGID

SENIUK RESIDENCE 528 TITAN STREET PHILADELPHIA, PA 19147 OWNER / BUILDER

DATE: _____



SHEET NUMBER	DRAWING TITLE	SHEET NUMBER	DRAWING TITLE	SHEET NUMBE
A-0.0	COVER SHEET	A-1.4	REFLECTED CEILING PLAN	M-1.0
A-0.1	COMPLIANCE PLAN & GENERAL NOTES	A-2.0	EXTERIOR ELEVATIONS	E-1.0
A-0.2	SITE PLAN	A-3.0	BUILDING SECTIONS	E-1.1
A-0.3	DEMOLITION PLAN	A-4.0	KITCHEN PLAN	P-1.0
A-1.0	FLOOR PLAN & DIMENSIONS	A-4.1	ROOF PLAN & DETAILS	P-1.1
A-1.1	FOUNDATION PLAN & DETAILS	A-5.0	DETAILS	
A-1.2	CONSTRUCTION PLAN	A-6.0	WINDOW, DOOR & FINISH SCHEDULES	

DRAWING INDEX

SHEET NUMBER	DRAWING TITLE
M-1.0	MECHANICAL PLAN - HVAC
E-1.0	ELECTRIC PLAN - 1RST & 2ND FLOORS
E-1.1	ELECTRIC PLAN - ATTIC & SCHEDULES
P-1.0	PLUMBING PLAN
P-1.1	PLUMBING NOTES & SCHEDULES

SYMBOL	DESCRIPTION	SYMBOL	DESCRIPTION
1/1/1/1	FINISHED WOOD		STEEL IN SECTION
	DIMENSION LUMBER		CAULKINGDETAILS
	FACE BRICK		BATT INSULATION
	RIGID INSULATION		STUCCO / DRYVIT
7 Ab. A A A A A A A A A A A A A A A A A A	CONCRETE		PLYWOOD
	C.M.U.		EARTH

COVER SHEET

RAWING NUMBER:

CONTRACT DRAWINGS ARE INTENDED TO REPRESENT DESIGN INTENT. DIMENSIONAL ACCURACY IS THE RESPONSIBILITY OF THE CONTRACTORS FOR ALL PHASES INCLUDING BIDDING, FABRICATION, COORDINATION, AND CONSTRUCTION. ANY DISCREPANCIES AND/OR OMISSIONS SHALL BE BROUGHT TO THE ARCHITECT'S ATTENTION FOR

GENERAL NOTES

ANY AREA OUTSIDE THE LIMITS OF CONSTRUCTION DISTURBED BY OPERATIONS OF THE CONTRACTOR SHALL BE RESTORED AT THE CONTRACTOR'S EXPENSE.

RESOLUTION.

- CONTRACTOR SHALL BE RESPONSIBLE FOR REMOVING ALL TEMPORARY **EQUIPMENT COVERINGS USED DURING** CONSTRUCTION AND FOR REMOVING HIS TRASH OFF OF THE JOB SITE DAILY
- ALL INTERIOR AND EXTERIOR WALL PENETRATIONS TO BE SEALED. REFER TO MECHANICAL, PLUMBING AND **ELECTRICAL DRAWINGS FOR DETAILS** OF UTILITY WALL PENETRATIONS.
- G.C. TO PROVIDE OPENINGS AS REQUIRED FOR MECHANICAL & **ELECTRICAL EQUIPMENT. CONTRACTOR** SHALL BE RESPONSIBLE FOR PROVISIONS AND INSTALLATION OF ALL SUPPLEMENTAL MISC. IRON AND/OR STRUCTURAL STEEL STUDDING REQUIRED TO ADEQUATELY SUPPORT ALL DRYWALL DROP SOFFITS, BULKHEADS, ETC. FROM THE STRUCTURE ABOVE.
- DRYWALL CONTRACTOR SHALL CLOSELY COORD. THE INSTALLATION OF THE REQ'D. SUPPLEMENTAL MISC. IRON AND/OR STRUCTURAL STL. STUDDING SO AS NOT TO INTERFERE WITH THE INSTALLATION OF DUCTWORK, PIPING, CONDUIT. SPRINKLER SYSTEM AND/OR ACOUSTICAL TILE SUSPENDED CEILING SYSTEM.
- ALL DRYWALL PARTITIONS EXTENDING TO UNDERSIDE OF DECK ABOVE SHALL HAVE A 3/4" SLIP CONNECTION AT TOP OF WALL.
- ALL DRYWALL PARTITIONS ARE DIMENSIONED FACE OF METAL OR WOOD STUDS.
- ALL DRYWALL PARTITIONS TO RECEIVE RECESSED ELECT. PANELS SHALL BE CONSTRUCTED OF 6" METAL OR WOOD STUDS.
- 10. WHERE TWO DISSIMILAR METALS MEET. PAINT FACE OF ONE WITH BITUMINOUS PAINT.
- 11. ALL WOOD BLOCKING & FRAMING IN **BUILDING TO BE FIRE RETARDANT** TREATED.
- ALL EXPOSED WOOD & METAL IS TO BE PAINTED.
- 13. IN CASE OF DIFFERENCE BETWEEN ARCH. & STRUCTURAL DRAWINGS, DIMENSIONS IN ARCH. DRAWINGS SHOULD BE FOLLOWED.

GOVERNING CODES

BUILDING/DWELLING CODE: IBC 2009; IRC2009

STRUCTURAL CODE:

PLUMBING CODE:

PHILADELPHIA

IMC 2009

IBC 2009

PLUMBING CODE

MECHANICAL CODE:

ELECTRICAL CODE:

IBC 2009: NEC 2008

IBC 2009, CH. 11 &

ICC/ANSI A117.1-2003

ACCESSIBILITY CODE:

IECC 2009

ADMINISTRATIVE CODE:

ENERGY CODE:

PHILADELPHIA

ADMINISTRATIVE CODE

PHILADELPHIA PROPERTY

MAINTENANCE CODE

PROPERTY CODE:

ZONING CLASSIFICATION

ZONING RESTRICTIONS

ZONING CLASSIFICATION:

PROPOSED USAGE:

RSA-5

SINGLE FAMILY RESIDENCE

LOT WIDTH (MINIMUM): 16 FT.

LOT AREA (MINIMUM): 1,440 SQ. FT.

FRONT SETBACK: THE FRONT SETBACK SHALL BE NO FURTHER FROM THE STREET THAN THE FURTHEST FRONT FAÇADE OF THE PRINCIPAL BUILDING ON EITHER OF THE TWO IMMEDIATELY ABUTTING LOTS, AND SHALL BE LOCATED NO CLOSER TO THE PRIMARY STREET THAN THE CLOSEST FRONT FAÇADE OF THE PRINCIPAL BUILDING ON EITHER OF THE TWO ABUTTING LOTS. IF BOTH ABUTTING LOTS ARE VACANT, SETBACK IS BASED ON THE CLOSEST BUILDING.

REAR YARD DEPTH (MINIMUM): THE GREATER OF 9 FT. OR 20 PERCENT OF THE LOT DEPTH.

SIDE YARD WIDTH (MINIMUM): 5 FT.

HEIGHT (MAXIMUM): 38 FT.

DEED RECORDED 4/5/2007. DOCUMENT ID #51665564

LEGAL DESCRIPTION

BEGINNING AT A POINT ON THE SOUTH SIDE OF TITAN STREET (30 FEET WIDE) SAID POINT BEING AT A DISTANCE OF 135.000 FEET EASTWARD FROM THE EAST SIDE OF SIXTH STREET (50 FEET WIDE).

CONTAINING IN FRONT OR BREADTH ALONG THE SOUTH SIDE OF TITAN ST. 16.667 FEET AND EXTENDING THAT LENGTH OR DEPTH SOUTHWARD BETWEEN PARALLEL LINES WHICH ARE PARALLEL TO SAID SIXTH STREET THE DISTANCE OF 39.100 FEET.

ST. CODE/HOUSE NO.: 77460-00528

CITY REGISTRY: 8S12-373

ADDITION ADD. **ALTERNATE** ALT. **ASPHALT** ASPH. **AVERAGE** AVG B.M. **BENCH MARK BACK OF CURB** B/C C.A.P. CONCRETE ASBESTOS PIPE

CIVIL ABBREVIATIONS

C.D. CONSTRUCTION DOCUMENTS CENTERLINE CL CONSTRUCTION CONST CONTINUOUS CONT. CONTRACTOR CONTR. D.G. **DECOMPOSED GRANITE**

DBL. DOUBLE DEMO **DEMOLITION**

DIA. DIAMETER **EACH** EA. EQ. **EQUAL EQUIPMENT** EQUIP. EST. **ESTIMATE EXC EXCAVATE EXIST EXISTING** FAB. **FABRICATE** FIN. FL HOR.

FINISH FLOOR HORIZONTAL **HYDRAULIC** MANHOLE MAT'L MATERIAL **MAXIMUM MANUFACTURING**

MFR. **MANUFACTURER** MIN. MINIMUM MISC **MISCELLANEOUS** N.I.C **NOT IN CONTRACT** N.T.S. NOT TO SCALE NFC NOT FOR CONSTRUCTION

NOM **NOMINAL** P.L. PROPERTY LINE PREFAB. **PREFABRICATED** QTY. QUANTITY R.O.W RIGHT OF WAY REF. REFERENCE

REQ'D REQUIRED REV. **REVISION** RMV. REMOVE SH SHEET SIM. SIMILAR **SPECS** SPECIFICATIONS

STD SYS. T.O.C. **THRU** TYP. V.I.F. WT.

W/O

HYD.

M.H

MAX.

MFG.

SYSTEM TOP OF CURB THROUGH **TYPICAL VERIFY IN FIELD** WEIGHT WITH

WITHOUT

STANDARD

YARD

OWNER / BUILDER / DESIGNER

OWNER / BUILDER: L. SENIUK ADDRESS:

732 SANSOM ST. #3 PHILADELPHIA, PA 19106-3215

TELE: 215-629-2812

DESIGNER: PHOTODESIGN.NET

BAER WOLFE ARCHITECTS ENGINEER/ARCH.

DRAFTING: S.R. HEYMAN

FREDERICK MUTUAL CO. **INSURANCE CO.:**


POLICY NO.: APP2080246

FIRE CODE COMPLIANCE

COMPLIANCE REFERENCES

- A. NATIONAL ELECTRIC CODE, ARTICLE 760.
- B. NATIONAL FIRE PROTECTION ASSOCIATION STANDARDS:
 - 1. NFPA 70 NATIONAL ELECTRICAL CODE
 - 2. NFPA 72 NATIONAL FIRE ALARM CODE.
 - 3. NFPA 101 LIFE SAFETY CODE.
- C. LOCAL AND STATE BUILDING CODES:
 - 1. BOCA, NATIONAL BUILDING CODE, MECHANICAL CODE, FIRE PREVENTION CODE.
- D. LOCAL AUTHORITIES HAVING FIRE PROTECTION JURISDICTION
- E. EQUIPMENT SHALL BE APPROVED BY THEUNDERWRITERS LABORATORIES, INC. FOR THE FOLLOWING STANDARDS AS APPLICABLE:
 - 1. UL 864 9TH EDITIONS UOJZ CONTROL UNITS FOR FIRE PROTECTIVE SIGNALING SYSTEMS.
 - 2. UL 268 SMOKE DETECTORS FOR FIRE PROTECTIVE SIGNALING SYSTEMS.
 - 3. UL 268A SMOKE DETECTORS FOR DUCT APPLICATIONS.
 - 4. UL 217 SMOKE DETECTORS FOR SINGLE STATION APPLICATION.
 - 5. UL 521 HEAT DETECTORS FOR FIRE PROTECTIVE SIGNALING SYSTEMS.
 - 6. UL 228 DOOR HOLDERS FOR FIRE PROTECTIVE SIGNALING SYSTEMS.
 - 7. UL 464 AUDIBLE SIGNALING APPLIANCES.
 - 8. UL 1638 VISUAL SIGNALING APPLIANCES.
 - 9. UL 38 MANUALLY ACTIVATED SIGNALING BOXES.
 - 10. UL 346 WATER FLOW INDICATORS FOR FIRE PROTECTIVE SIGNALING SYSTEMS.
 - 11. UL 1481 POWER SUPPLIES FOR FIRE PROTECTIVE SIGNALING SYSTEMS.

SYMBOLS

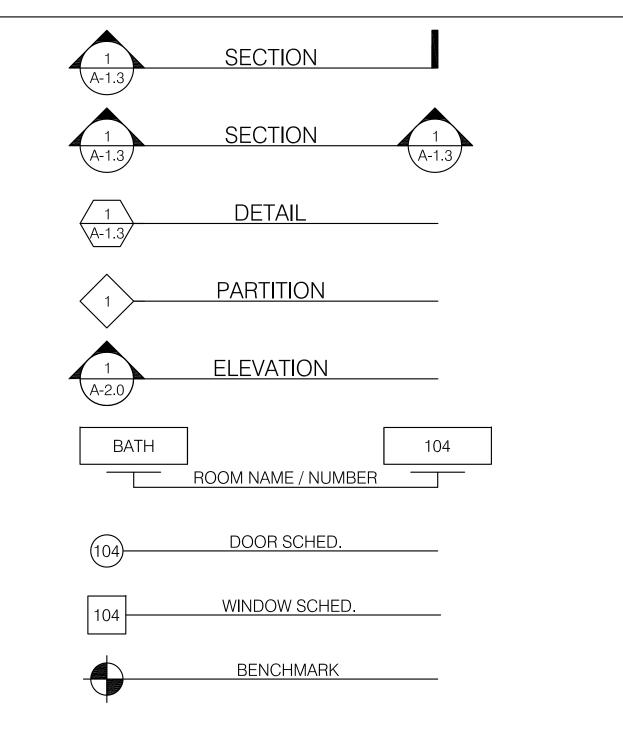



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DATE: 10/15/2013 SCALE: N.T.S. PROJECT: SENIUK RESIDENCE REVISION: **DRAWN BY:** SRH 2.01

> COMPLIANCE PLAN & GENERAL NOTES

PROPERTY DESCRIPTION


DEED RECORDED 4/5/2007. DOCUMENT ID #51665564

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CONTAINING IN FRONT OR BREADTH ALONG THE SOUTH SIDE OF TITAN ST. 16.667 FEET AND EXTENDING THAT LENGTH OR DEPTH SOUTHWARD BETWEEN PARALLEL LINES WHICH ARE PARALLEL TO SAID SIXTH STREET THE

SURVEY & DEED

SITUATED IN THE 2ND WARD OF THE CITY OF PHILADELPHIA AND DESCRIBED ACCORDING TO A PLAN OF PROPERTY MADE BY PAUL N. LONIE, SURVEYOR AND REGULATOR OF THE 2ND SURVEY DISTRICT DATED 11-2-1994. BEING THESAME PREMISES WHICH ROBERT IOVINO AND ETHEL IOVINO BY DEED DATED 3-27-2007.



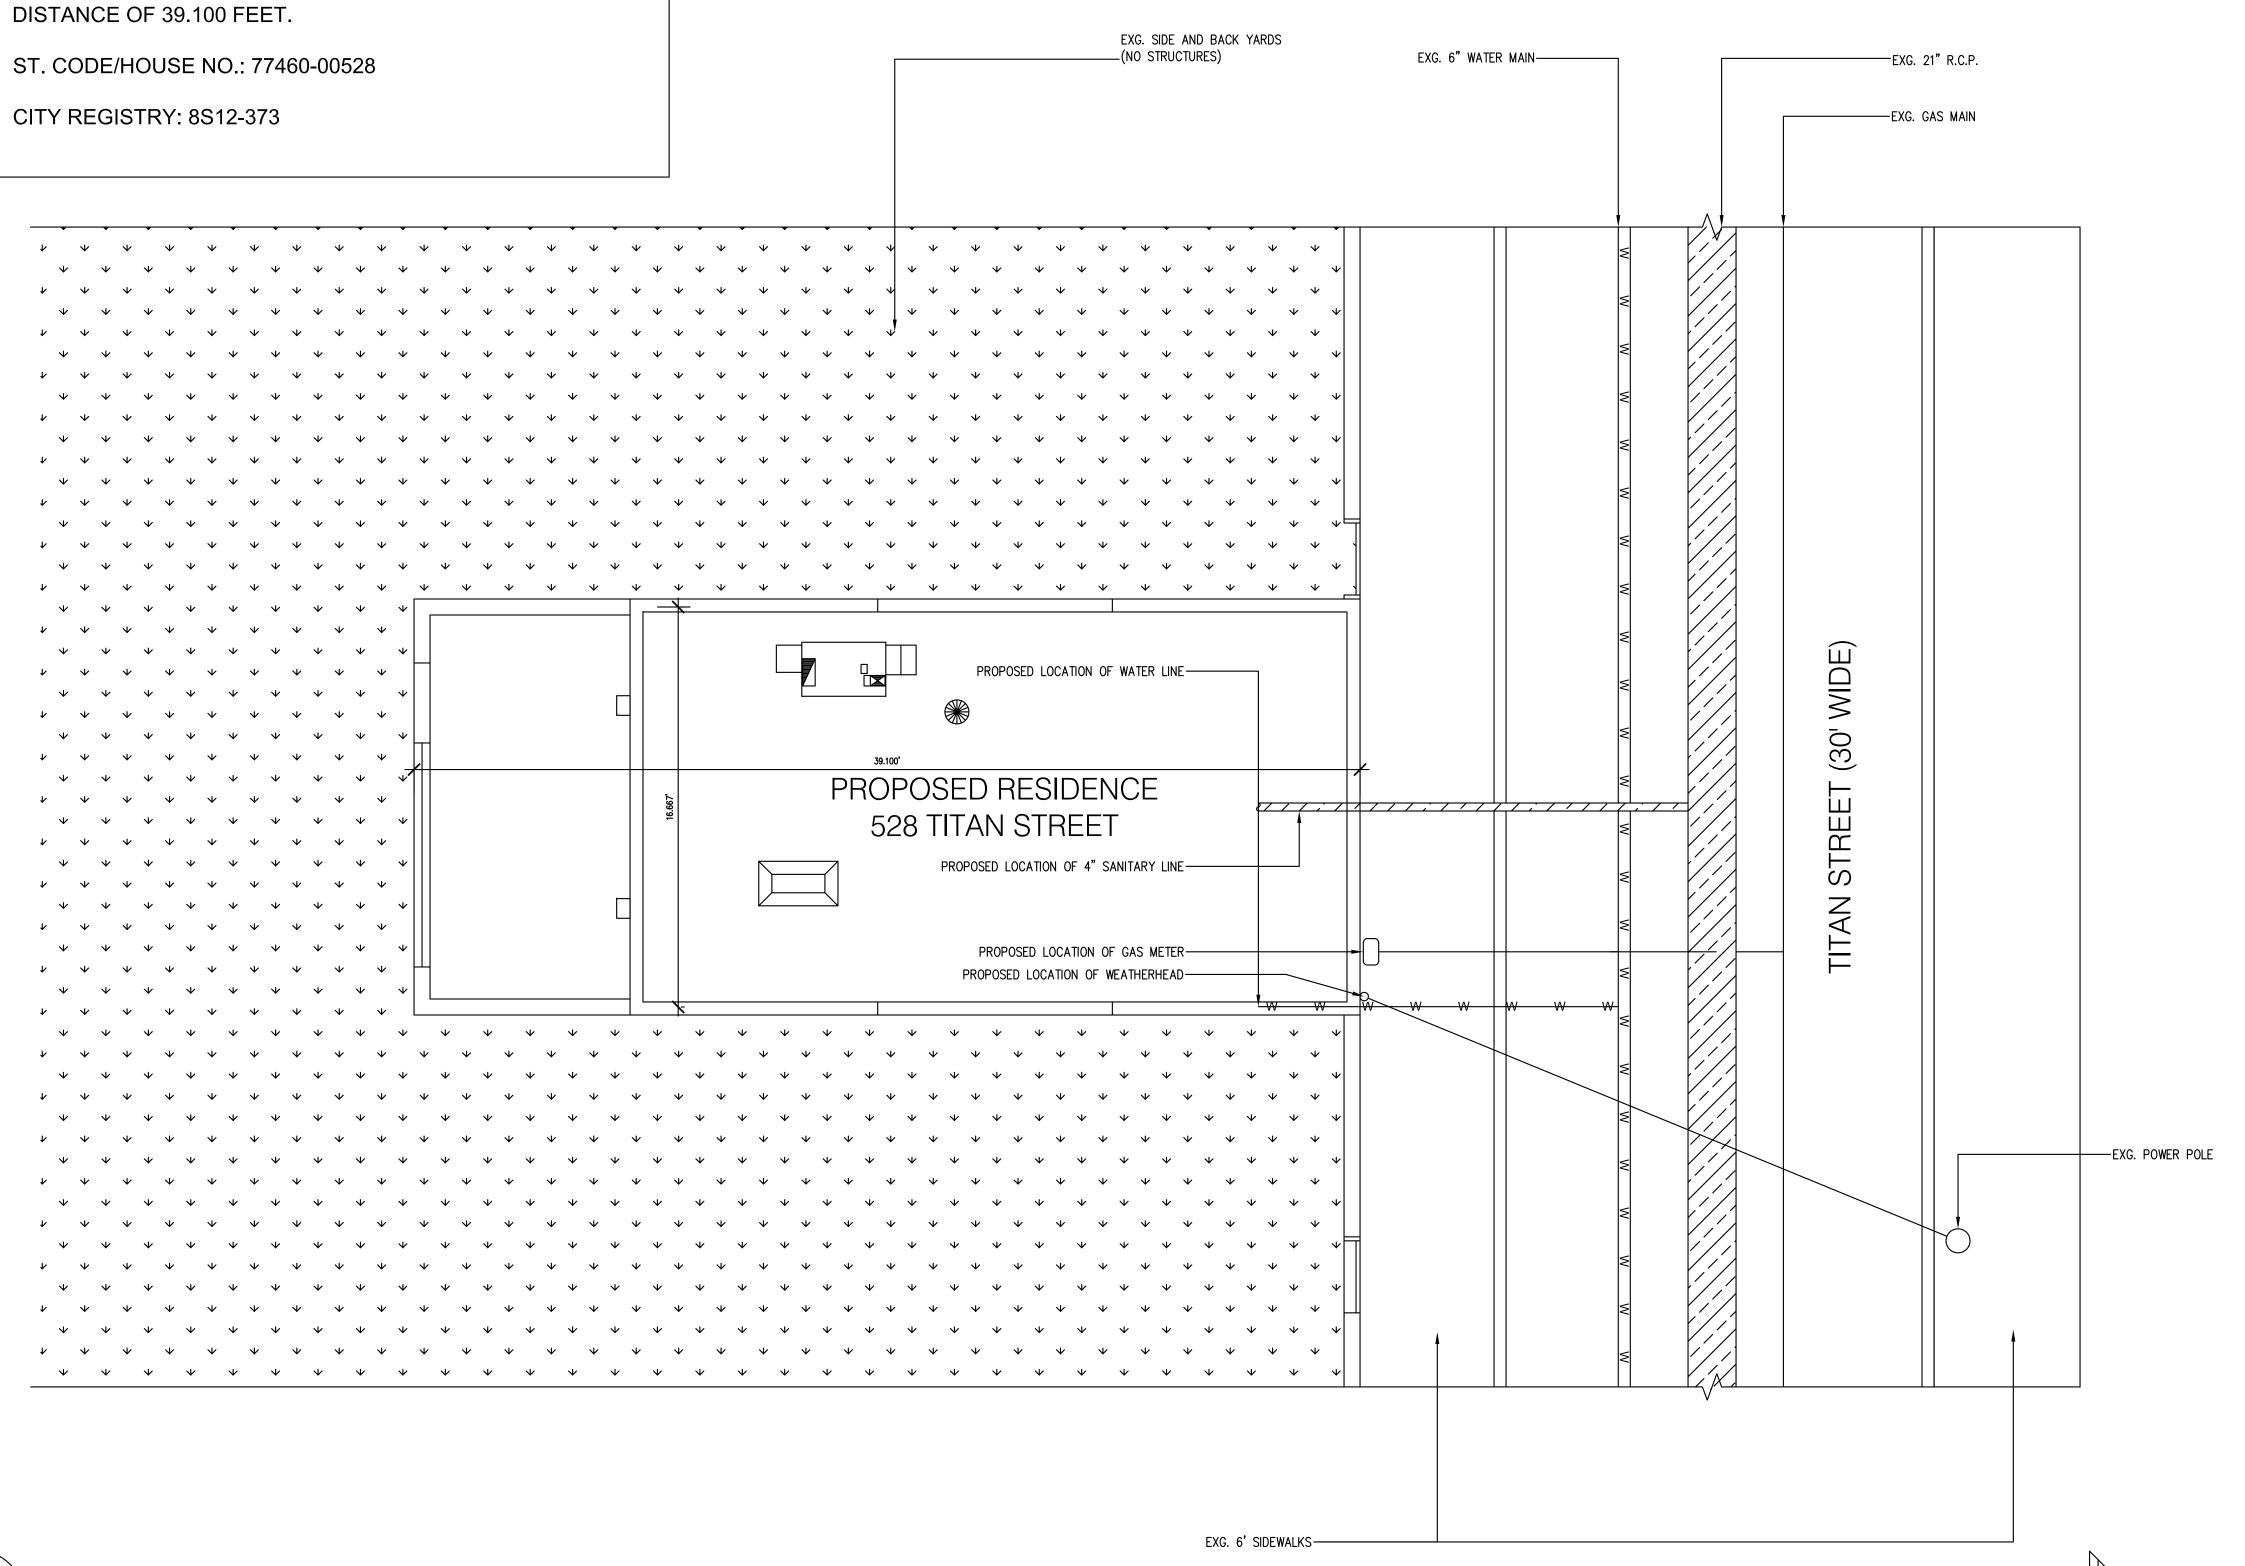


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10/15/2013 1/4" = 1'-0" PROJECT: SENIUK RESIDENCE **REVISION:** 2.01 SITE PLAN


DRAWING NUMBER:

SITE PLAN

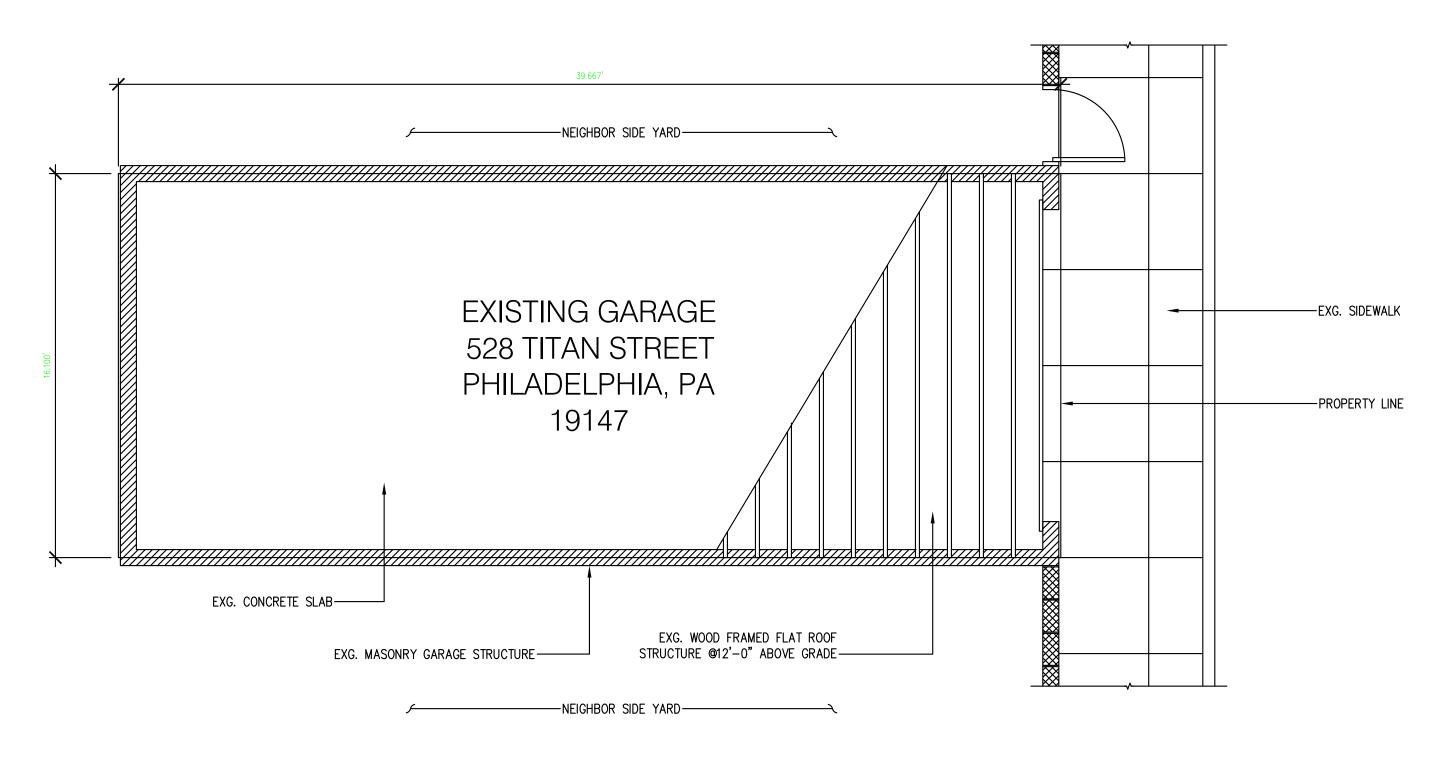

A EXISTING PLAN

0.2 SCALE: 1/4" = 1'-0"

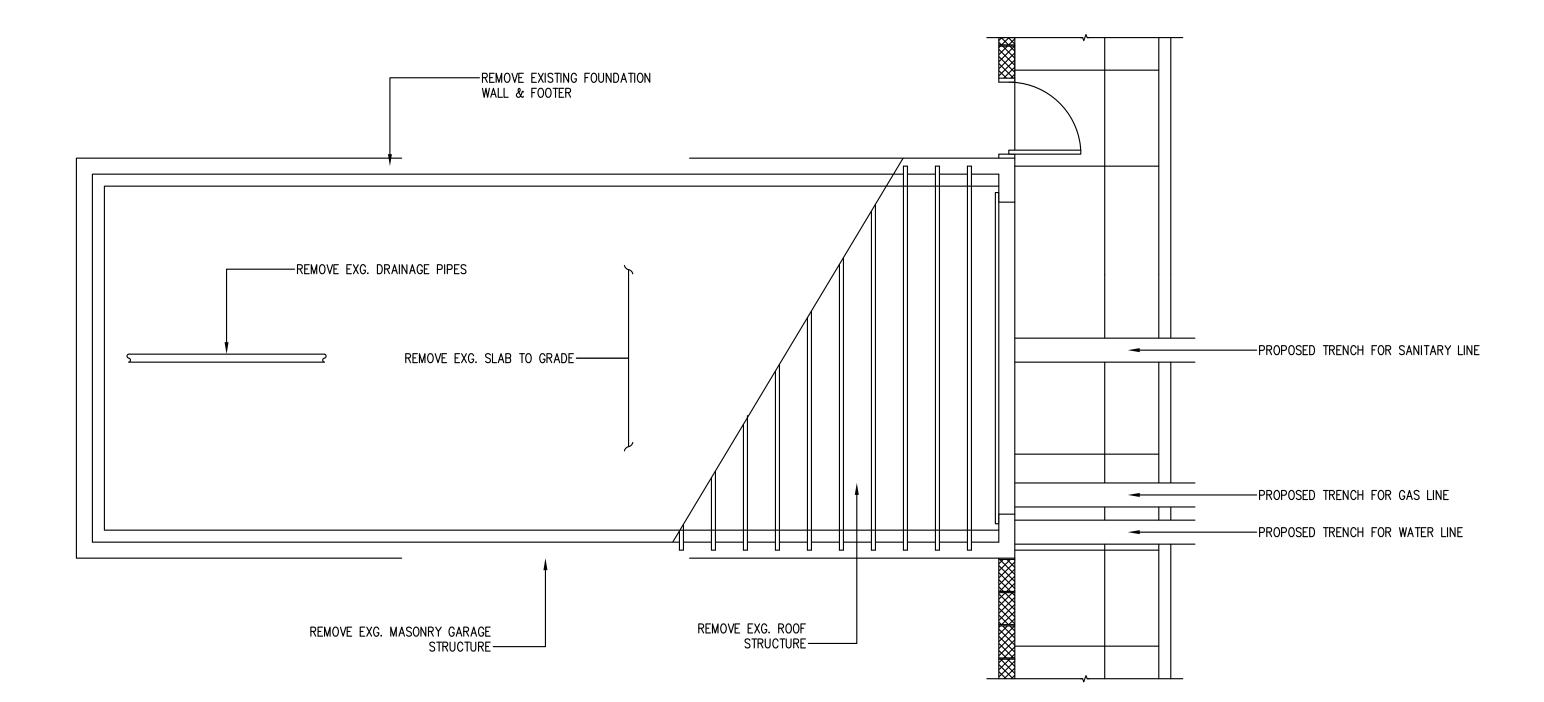

A DEMOLITION PLAN

0.2 SCALE: 1/4" = 1'-0"

DEMOLITION NOTES

- 1.) DASHED LINES ON DEMO PLANS REPRESENT WALLS, DOORS, ETC TO BE REMOVED. PATCH & REPAIR EXISTING ADJOINING AREAS TO REMAIN.
- 2.) THE CONTRACTOR SHALL NOT CONSIDER DEMOLITION AND ALTERATION NOTES TO BE ALL-INCLUSIVE. IT IS CONTRACTOR'S RESPONSIBILITY TO INSPECT AND ASSESS EACH AREA AND TO FULFILL THE INTENT OF THE DESIGN INDICATED BY THE CONTRACT DOCUMENTS.
- 3.) THE CONTRACTOR SHALL VERIFY ALL CONDITIONS AND DIMENSIONS WITHIN THE CONTRACT LIMITS AND NOTIFY THE ARCHITECT IMMEDIATELY IN WRITING OF ANY DEVIATION FROM CONTRACT DOCUMENTS NECESSITATED BY FIELD CONDITIONS OR ITEMS NOT COVERED.
- 4.) FOR ALL SURFACES SCHEDULED TO REMAIN, PATCH AND MATCH SURFACES DISTURBED Y DEMOLITION OR REMOVAL OF EQUIPMENT OR UTILITIES. INSTALL PATCHING TO MATCH DJACENT WORK IN FINISH, STRUCTURAL QUALITIES, COURSING OF MASONRY, AND OTHER CHARACTERISTICS.
- 5.) ALL DEMOLITION SHALL BE PERFORMED IN A SAFE AND ACCEPTABLE MANNER TO ALL UTHORITIES HAVING JURISDICTION AND THE OWNER. A FIRE WATCH SHALL BE PROVIDED IF ANY HAZARDOUS SITUATIONS ARE THOUGHT TO BE POSSIBLE. COMPLY WITH GOVERNING REGULATIONS PERTAINING TO ENVIRONMENTAL PROTECTION FOR POLLUTION CONTROL. THOROUGHLY CLEAN ADJACENT AREAS OF DUST, DIRT AND DEBRIS CAUSED BY DEMOLITION WORK.
- 6.) PROVIDE TEMPORARY PARTITIONS/DUST PROTECTION (RATED AND/OR NON-RATED) AS REQUIRED. REVIEW LOCATIONS OF TEMPORARY PARTITIONS/DUST PROTECTION WITH OWNER AND ARCHITECT PRIOR TO START OF WORK.
- 7.) HAZARDOUS MATERIAL NOTE: CONTRACTOR SHALL STOP WORK AND INFORM OWNER IMMEDIATELY IN WRITING OF ANY HAZARDOUS MATERIAL ENCOUNTERED OR THOUGHT TO BE HAZARDOUS MATERIAL. THE OWNER, AFTER RECEIVING WRITTEN NOTICE SHALL INSTRUCT CONTRACTOR ON HOW TO PROCEED.
- 8.) ALL WORK SHALL BE DONE IN PROTECTED SPACE. NO DUST OR DIRT SHALL TRAVEL FROM CONSTRUCTION AREA TO ADJACENT AREAS. TEMPORARY DUST PROTECTION SHALL BE ERECTED PRIOR TO START OF WORK.
- 9.) PRIOR TO ANY DEMOLITION, THE CONTRACTOR SHALL COORDINATE BRACING AND MAINTAIN THE STRUCTURAL INTEGRITY OF THE REMAINING ELEMENTS OF THE BUILDING ND ITS SYSTEMS AS REQUIRED. THE CONTRACTOR SHALL BE RESPONSIBLE FOR THE SUPPORT OF ADJACENT STRUCTURES DURING DEMOLITION AND NEW CONSTRUCTION WORK. THE CONTRACTOR SHALL PROVIDE ALL TEMPORARY SHORING, SCAFFOLDING, ETC., WHICH ARE NECESSARY TO PREVENT COLLAPSE, SUBSIDENCE, DEFLECTION OR ANY OTHER TYPE OF DAMAGE. REPAIR SPRAY FIREPROOFING DAMAGED DURING DEMOLITION WORK TO ITS REQUIRED ASSEMBLY AND FIRE RATING AS SCHEDULED ON ARCHITECTURALDRAWINGS.
- 10.) CONTRACTOR SHALL REVIEW ALL ITEMS TO BE DEMOLISHED WITH OWNER TO IDENTIFY ANY ITEMS TO BE SALVAGED PRIOR TO START OF DEMOLITION.
- 11.) ANY FLOOR OPENINGS SHALL BE COVERED DURING DEMOLITION AND CONSTRUCTION



SENIUK RESIDENGE 528 TITAN STREET PHILADELPHIA, PA 19147

DATE:

10/15/2013

SCALE:

1/4" = 1'-0"


PROJECT: SENIUK
RESIDENCE

DRAWN BY: REVISION:
SRH 2.01

DRAWING TITLE:
DEMOLITION

A-0.3


PLAN

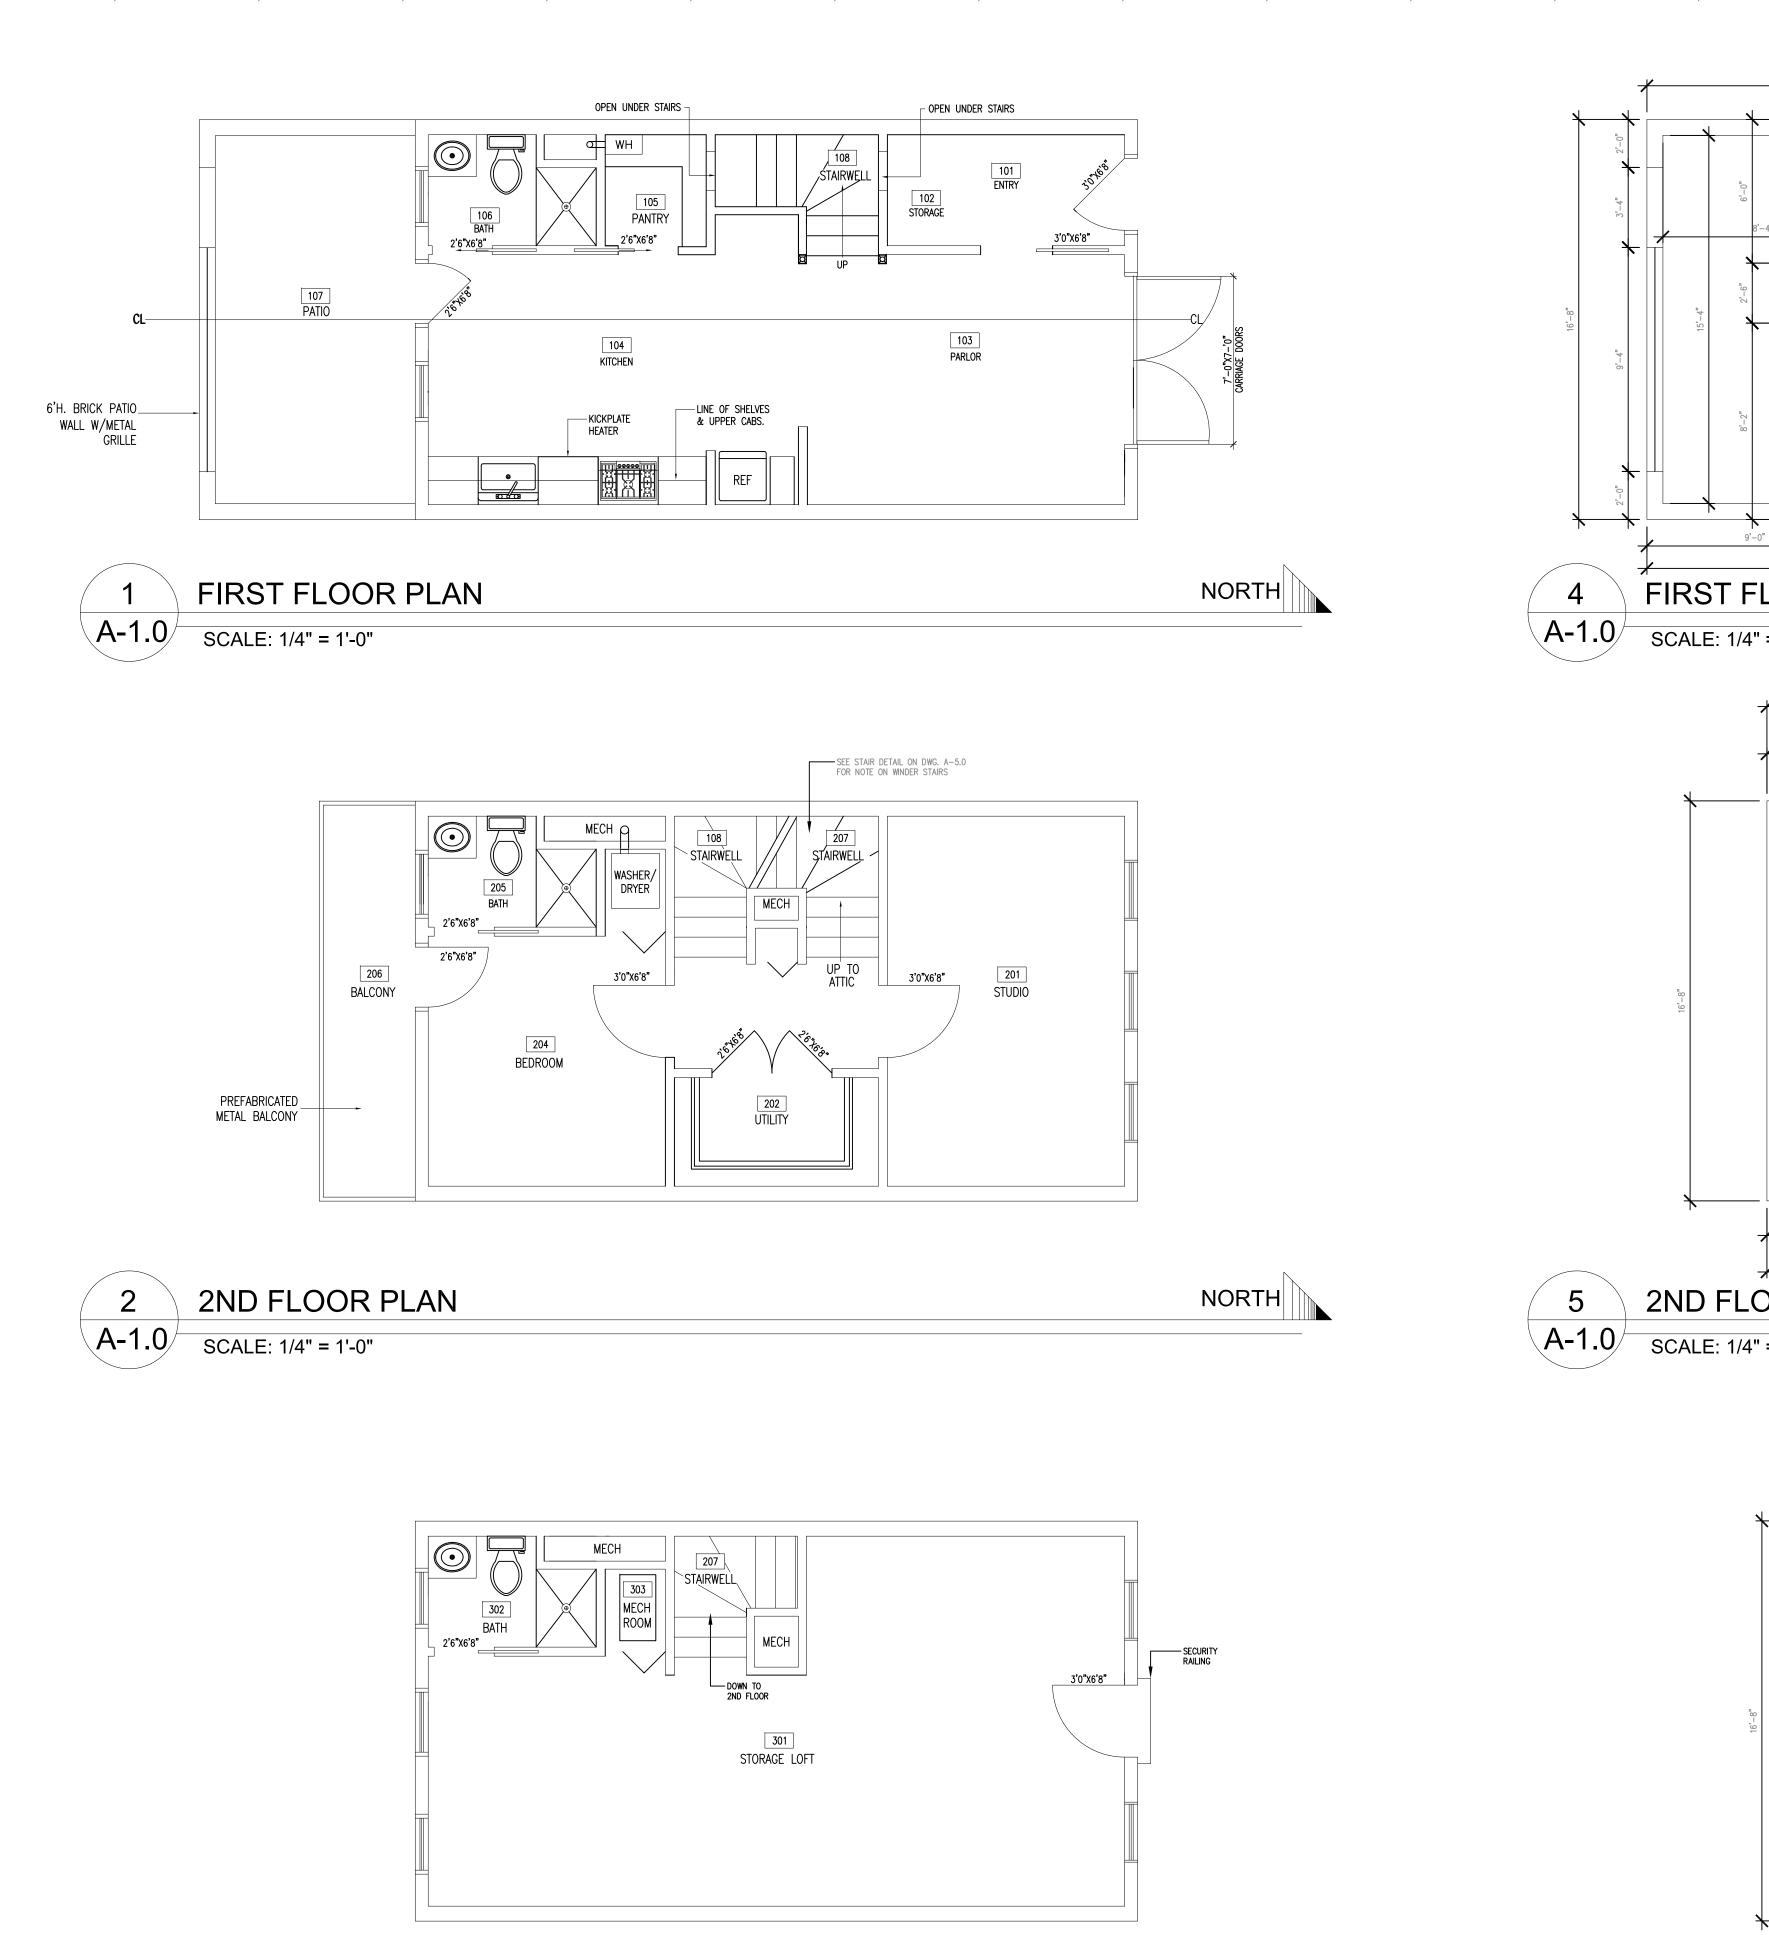

ATTIC PLAN


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NORTH



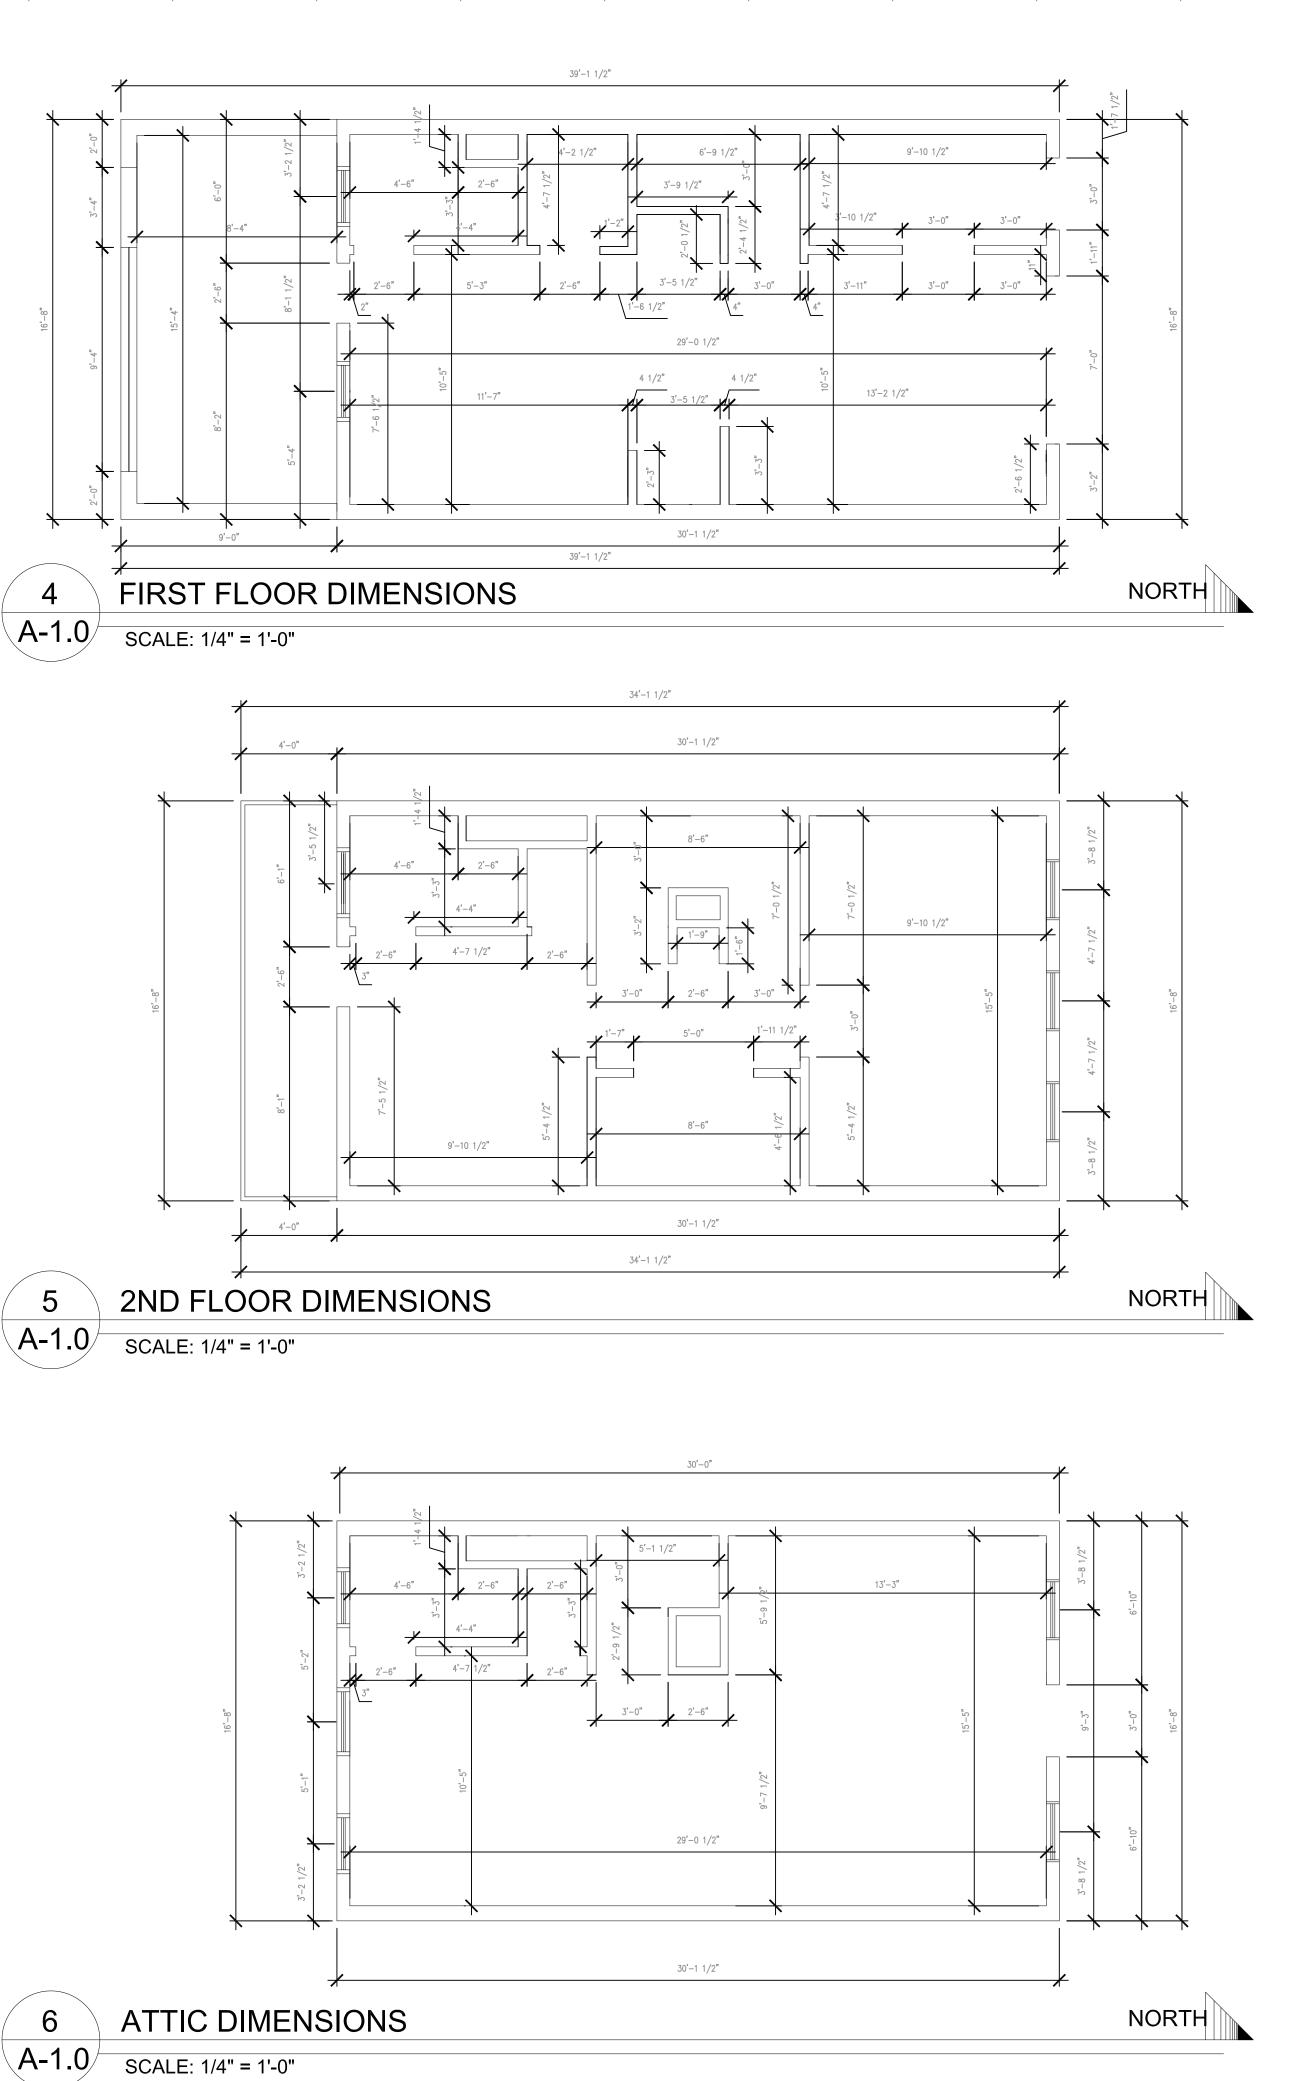

SENIUK RESIDENCE 528 TITAN STREET PHILADELPHIA, PA 19147

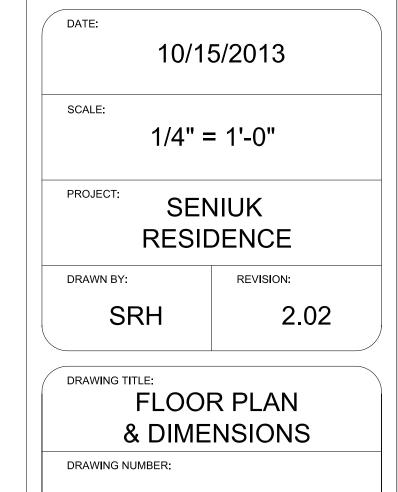


A-1.0

B" BRICK GARDEN WALL 5% GRADE EXTERIOR GRADE 8" CMU - FILLED AS REQU. EXTERIOR PARGING GARDEN WALL FOOTER 44 REINFORCING BAR 49 24" O.C. COMPACTE SOIL 44 REINFORCING BAR 49 24" O.C.

FOUNDATION DETAIL - 2

SCALE: 1" = 1'-0"


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FOUNDATION NOTES

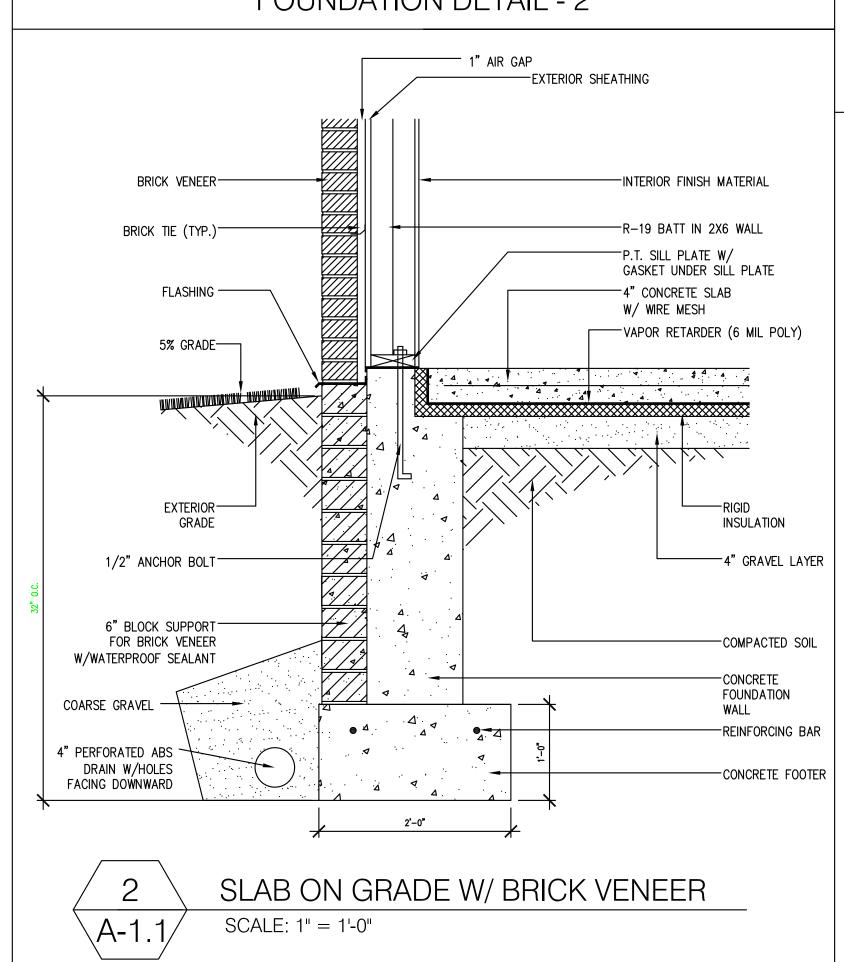- 1. SILL PLATE: THE SILL PLATE SHOULD BE AT LEAST 8 INCHES ABOVE GRADE AND PRESSURE-PRESERVATIVE TREATED TO RESIST DECAY.
- 2. INSULATION PROTECTION: EXTERIOR INSULATION MATERIALS SHOULD NOT BE EXPOSED ABOVE GRADE. THE ABOVE-GRADE MATERIAL SHOULD BE COVERED BY A PROTECTIVE MATERIAL I.E. EXTERIOR GRADE PLASTIC, FIBERGLASS, NON-CORROSIVE FLASHING, OR A CEMENTITIOUS COATING EXTENDING AT LEAST 6 INCHES BELOW GRADE.
- 3. SURFACE DRAINAGE: THE GROUND SHOULD SLOPE DOWNWARD AT THE LEAST 5 PERCENT (6 INCHES) OVER THE FIRST 10 FEET SURROUNDING THE FOUNDATION EDGE TO DIRECT SURFACE RUNOFF AWAY FROM THE BUILDING. DOWNSPOUTS AND GUTTERS SHOULD BE USED TO COLLECT ROOF DRAINAGE AND DIRECT IT AWAY FROM THE FOUNDATION WALLS.
- 4. ANCHOR BOLTS FOR CONCRETE OR CMU WALLS: ANCHOR BOLTS SHOULD BE EMBEDDED IN THE TOP OF CONCRETE FOUNDATION WALLS. MOST CODES REQUIRE BOLTS OF 1/2-INCH DIAMETER TO BE EMBEDDED AT LEAST 7 INCHES INTO THE WALL. GENERALLY, ANCHOR BOLTSWILL BE PLACED AT 32" O.C. AND NO FURTHER THAN 1 FOOT FROM ANY CORNER.
- 5. ANCHOR BOLTS FOR MASONRY WALLS: ANCHOR BOLTS SHOULD BE EMBEDDED IN THE TOP OF MASONRY FOUNDATION WALLS. MOST CODES REQUIRE BOLTS OF 1/2-INCH MINIMUM DIAMETER EMBEDDED AT LEAST 7 INCHES INTO THE WALL. IN SOME LOCATIONS, CODES REQUIRE BOLTS TO BE EMBEDDED 15 INCHES IN THE MASONRY WALLS TO RESISTUPLIFT. TO PROVIDE ADEQUATE ANCHORAGE IN A MASONRY WALL, BOLTS EITHER MUST BE EMBEDDED IN A BOND BEAM OR THE APPROPRIATE CORES OF THE UPPER COURSE OF BLOCK MUST BE FILLED WITH MORTAR. ANCHOR BOLTS CAN BE PLACED AT A MAXIMUM SPACING OF 6 FEET AND NO FURTHERTHAN 1 FOOT FROM ANY CORNER.
- 6. EXTERIOR INSULATION MATERIALS: ACCEPTABLE MATERIALS FOR EXTERIOR FOUNDATION INSULATION ARE: (1) EXTRUDED POLYSTYRENE BOARDS (XEPS) UNDER ANY CONDITION, (2) MOLDED EXPANDED POLYSTYRENE BOARDS (MEPS) FOR VERTICAL APPLICATIONS WHEN POROUS BACKFILL AND ADEQUATE DRAINAGE ARE PROVIDED, AND (3) FIBERGLASS OR POLYSTYRENE DRAINAGE BOARDS WHEN INSTALLED WITH AN APPROPRIATE DRAINAGE SYSTEM.
- 7. CAST-IN-PLACE CONCRETE WALL: CONCRETE USED IN THE WALL SHOULD HAVE A MINIMUM COMPRESSIVE STRENGTH OF 2500 PSI WITH A 4- TO 6-INCH SLUMP. NO ADDITIONAL WATER SHOULD BE ADDED AT THE JOB SITE.GENERALLY, WHERE THERE ARE STABLE SOILS AND LOW SEISMIC ACTIVITY, NO REINFORCING IS REQUIRED.
- 8. CONCRETE/MASONRY WALL: GENERALLY, WHERE THERE ARE STABLE SOILS AND IN AREAS OF LOW SEISMIC ACTIVITY, NO REINFORCING IS REQUIRED.

- 8. CRACK CONTROL REINFORCING IN FOOTING: REINFORCING BARS PLACED 2 INCHES BELOW THE TOP OF THE FOOTING OR 2 INCHES ABOVE THE BOTTOM OF THE GRADE BEAM, RUNNING PARALLEL TO THE WALL, ARE RECOMMENDED WHERE DIFFERENTIAL SETTLEMENT IS A POTENTIAL PROBLEM.
- 9. CONCRETE FOOTINGS: CONCRETE FOOTINGS SHOULD BE DESIGNED TO DISTRIBUTE THE LOAD TO THE SOIL AND BE PLACED BENEATH THE MAXIMUM FROST PENETRATION DEPTH UNLESS FOUNDED ON BEDROCK OR PROVEN NON-FROST-SUSCEPTIBLE SOIL, OR INSULATED TO PREVENT FROST PENETRATION. CONCRETE SHOULD HAVE A MINIMUM COMPRESSIVE STRENGTH OF 2500 PSI.
- 10. ISOLATION JOINT: AN ISOLATION JOINT SHOULD BE PROVIDED AT THE SLAB EDGE TO PERMIT INDEPENDENT MOVEMENT WITHOUT CRACKING. WHERE RADON IS ACONCERN, A LIQUID SEALANT SHOULD BE POURED INTO THEJOINT OVER A FOAM BACKING ROD.
- 11. CONCRETE SLAB: A MINIMUM SLAB THICKNESS OF 4INCHES IS RECOMMENDED USING CONCRETE WITH A MINIMUM COMPRESSIVE STRENGTH OF 2500 PSI. WELDED WIRE FABRIC PLACED 2 INCHES BELOW THE SLAB SURFACE IS RECOMMENDED TO CONTROL SHRINKAGE CRACKS. GENERALLY, CONCRETE SLABS SHOULD NOT REST ON FOOTINGS OR LEDGES OF FOUNDATION WALLS IF POSSIBLE TO AVOID CRACKING DUE TO SETTLEMENT. IF A SLAB IS POURED DIRECTLY OVER AN IMPERMEABLE VAPOR RETARDER OR INSULATION BOARD, A CONCRETE MIXTURE WITH A LOW WATER/ CEMENT RATIO IS RECOMMENDED. AN ALTERNATIVE TECHNIQUE IS TO POUR THE SLAB ON A LAYER OF SAND OR DRAINAGE BOARD MATERIAL ABOVE THE VAPOR RETARDER TO MINIMIZE CRACKING.
- 12. VAPOR RETARDER: A 6-MILLIMETER POLYETHYLENE VAPOR RETARDER SHOULD BE PLACED BENEATH THE SLAB TO REDUCE MOISTURE TRANSMISSION AND RADON INFILTRATION INTO THEBUILDING.
- 13. GRAVEL LAYER UNDER SLAB: A 4-INCH COMPACTED GRAVEL LAYER SHOULD BE PLACED UNDER THE CONCRETE FLOOR SLAB FOR DRAINAGE.
- 14. INSULATION UNDER THE SLAB: ACCEPTABLE MATERIALS FOR UNDERSLAB INSULATION ARE: (1) EXTRUDED POLYSTYRENE BOARDS (XEPS) UNDER ANY CONDITION, (2) MOLDED EXPANDED POLYSTYRENE BOARDS (MEPS) WHEN THE COMPRESSIVE STRENGTH IS SUFFICIENT AND ADEQUATE DRAINAGE IS PROVIDED, AND (3) INSULATING DRAINAGE BOARDS WITH SUFFICIENT COMPRESSIVE STRENGTH.
- 15. INTERIOR RIGID INSULATION MATERIALS: ACCEPTABLE MATERIALS FOR PLACEMENT INSIDE A FOUNDATION WALL INCLUDE (1) EXTRUDED POLYSTYRENE BOARDS (XEPS) AND (2) EXPANDED POLYSTYRENE BOARDS (MEPS).



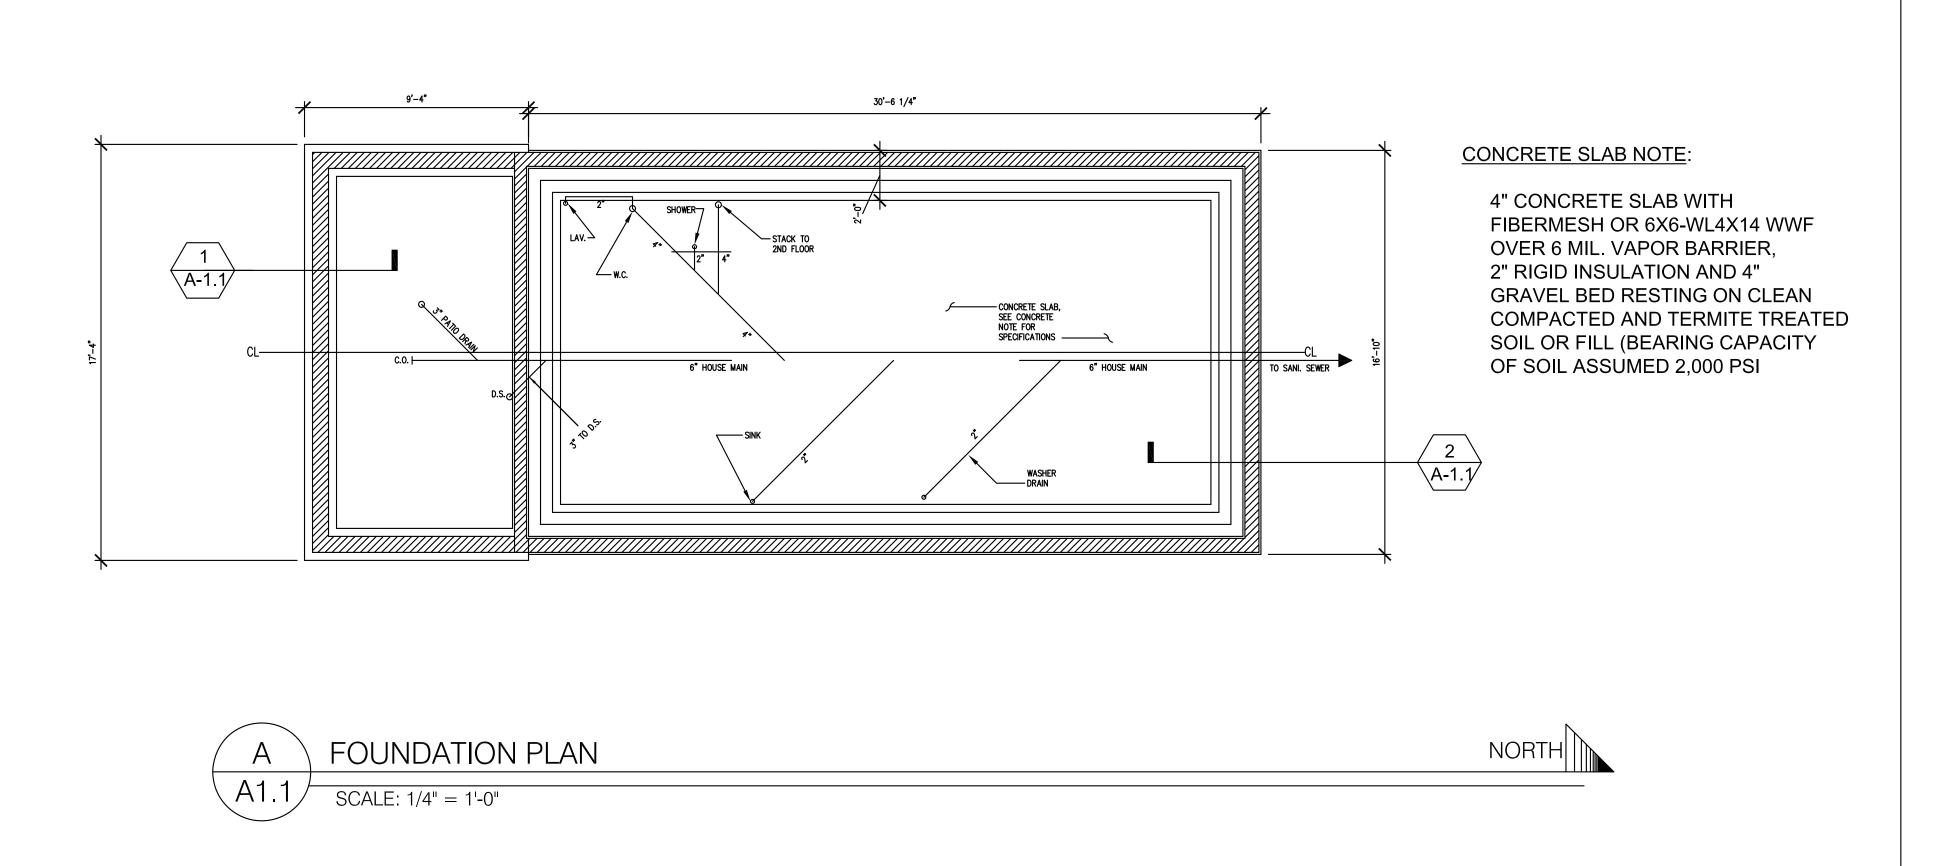

PHILADELPHIA, PA 19147

10/15/2013

AS INDICATED

SENIUK RESIDENCE


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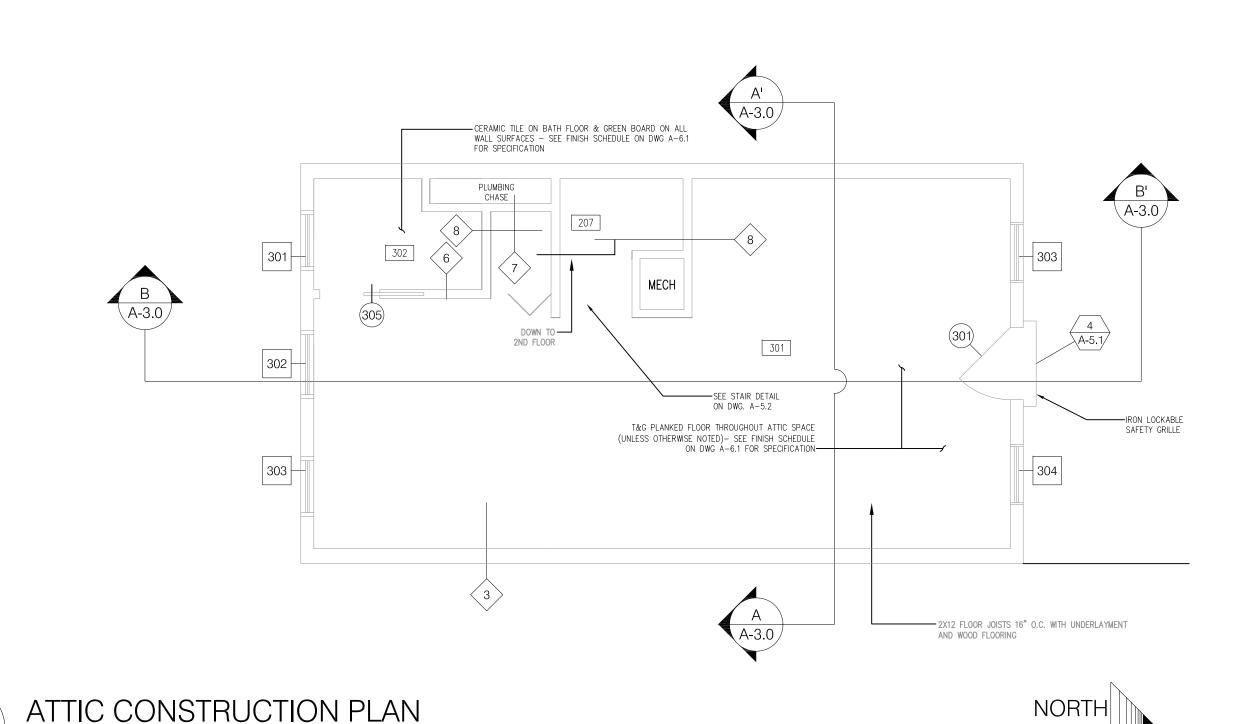
DRAWING NUMBER

SRH 2.01

FOUNDATION PLAN & DETAILS

A-1.1



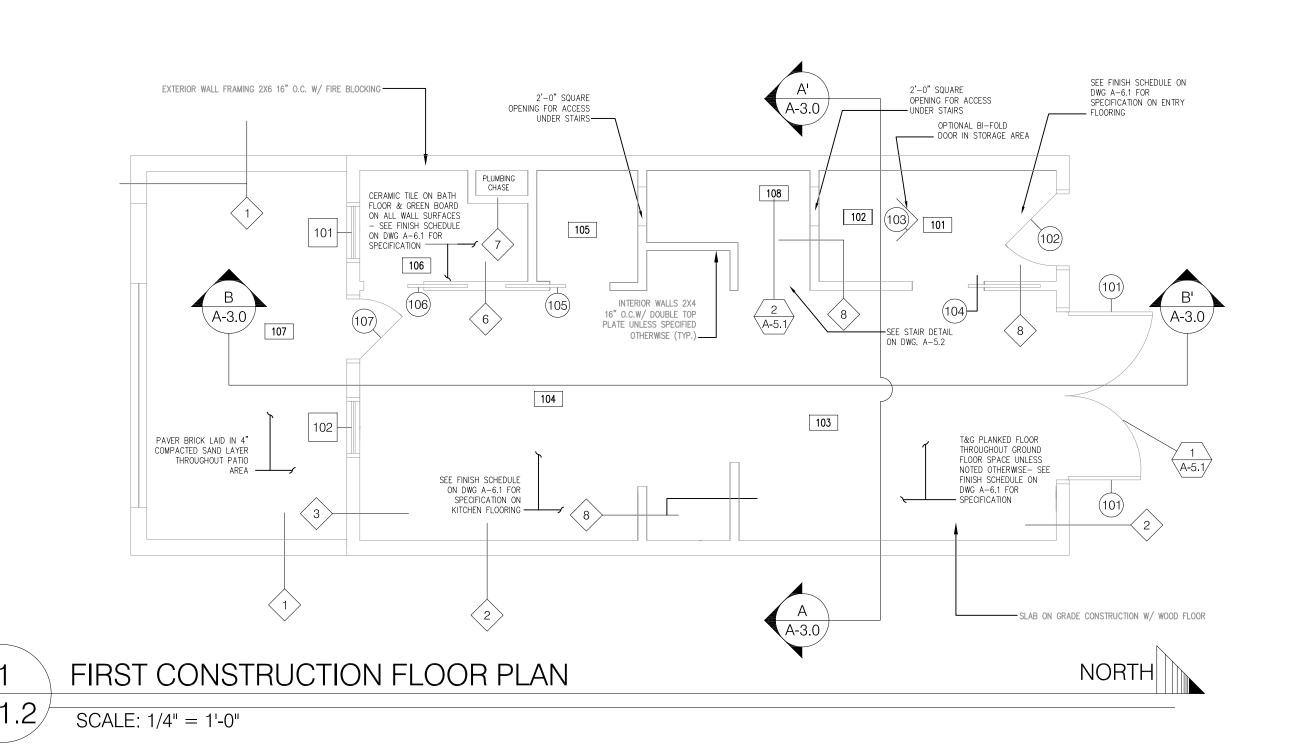




1. PRIMARY CONSTRUCTION TYPE IS PLATFORM FRAMED MULTI-STORY SLAB ON GRADE METHOD. RESIDENCE IS CONSTRUCTED ON A "ZERO-LOT-LINE BASIS IN ORDER TO ALLOW FUTURE DEVELOPMENT OF ADJACENT LOTS WITH NO ISSUE OF NON-COMPATIBLE INTERFACE.

SCALE: 1/4" = 1'-0"


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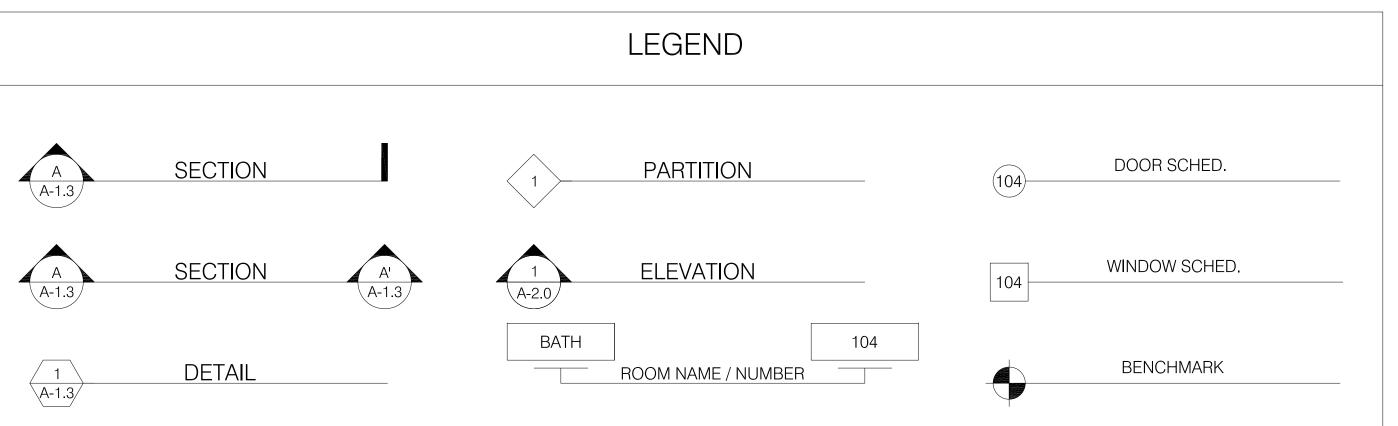
- 2. WATER DRAINAGE FROM ROOF IS TRANSMITTED VIA THE GUTTER AND DOWNSPOUT TO THE SANITARY STORM SEWER.
- 3. ALL STRUCTURAL LUMBER USED FOR JOISTS IS TO BE KD STRUCTURAL SELECT DOUGLAS FIR. WALL FRAMING TO BE KD NO. 2 OR BETTER. ALL SHEATHING TO BE APA 15/32 CD RATED FOR EXPOSURE 1.
- 4. SUBFLOORS TO BE CONSTRUCTED OF APA 23/32 CD RATED FOR SUBFLOOR EXPOSURE 1 WITH TONGUE AND GROOVE INTERFACE AND TOUCH SANDED.
- 5. PRIMARY WALL INSULATION TO BE OWENS CORNING R19 FSK 6-1/2X16X96 OR EQUIVALENT. RESIDENCE TO BE WRAPPED WITH TYVEK MOISTURE BARRIER.
- 6. ROOF TO HAVE A DUAL INSULATION SYSTEM. R-19 BATT TO BE PLACED WITHIN JOIST SPACE WITH 2" VENTED AIR SPACE. THE SECOND LAYER OF INSULATION WILL BE R-24 RIGID FOAM PLACED ABOVE MOISTURE BARRIER AND ROOF SHEATHING. THIS LAYER TO BE COVERED BY SINGLE MEMBRANE M-CLASS EDPM.

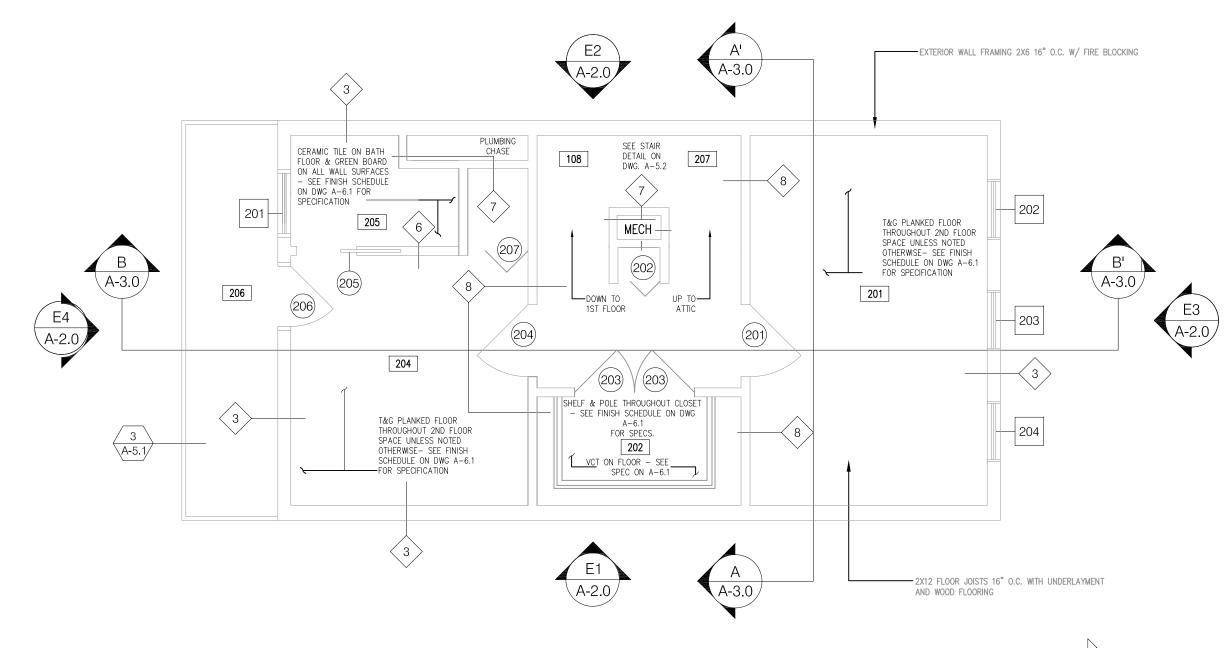

2 2ND CONSTRUCTION FLOOR PLAN

SCALE: 1/4" = 1'-0"




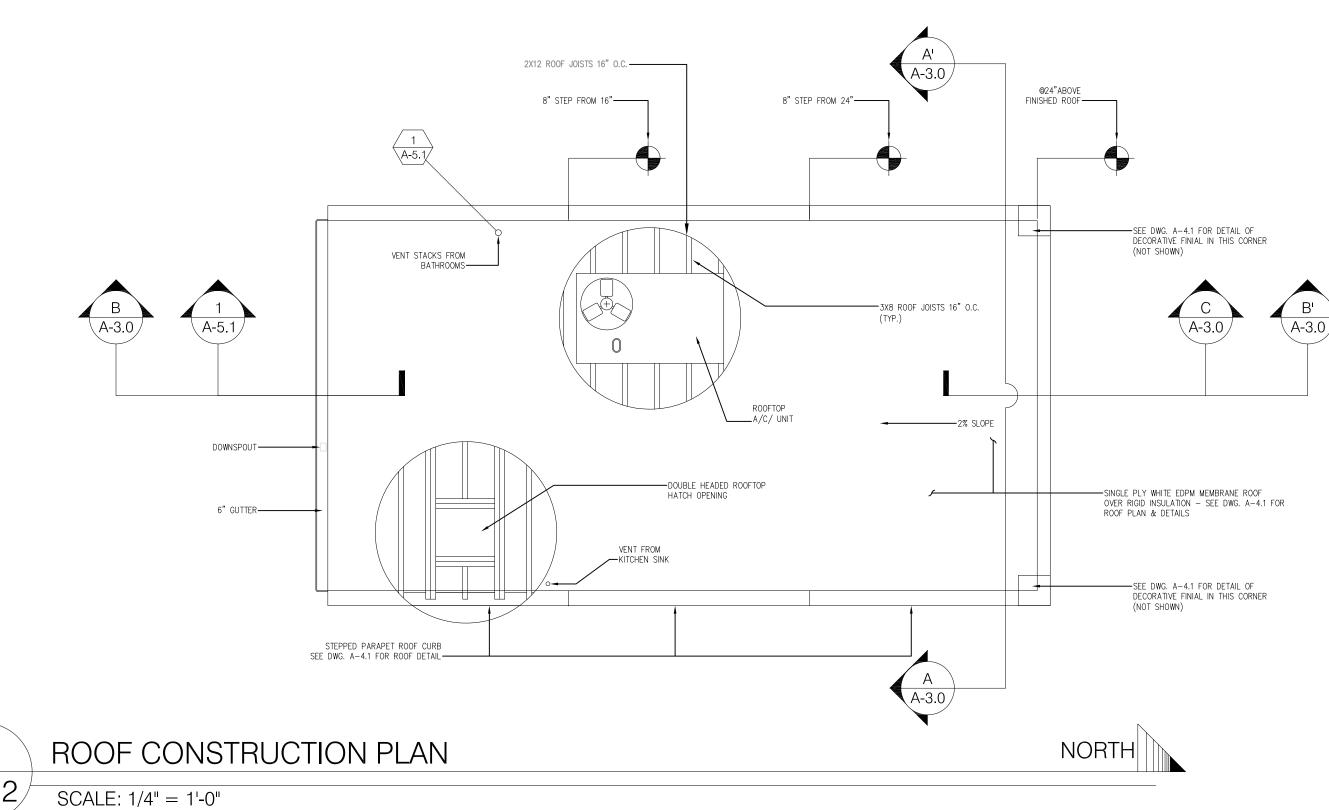



SENIUK RESIDENGE 528 TITAN STREET PHILADELPHIA, PA 19147


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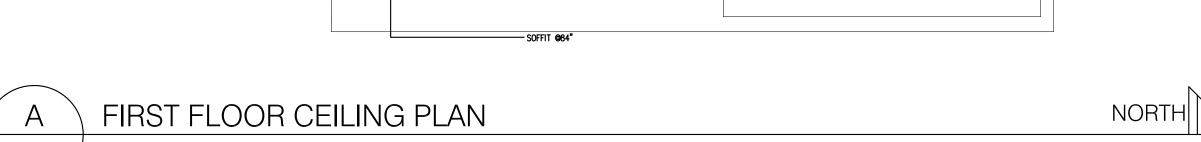

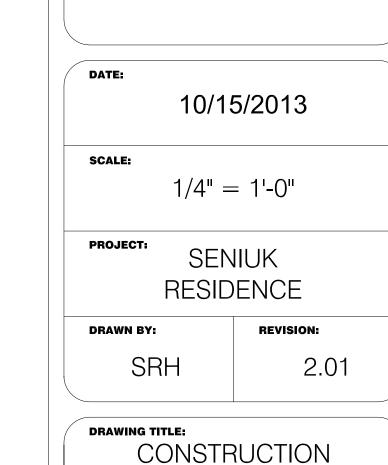
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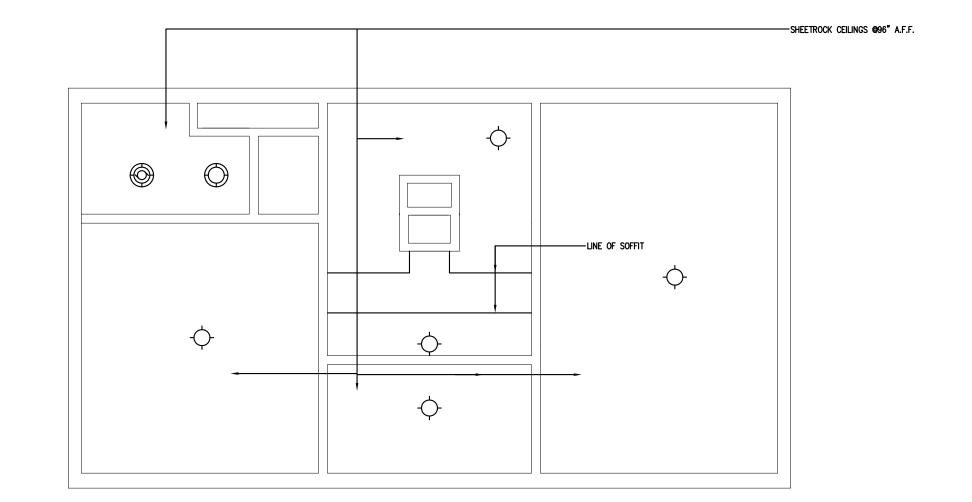
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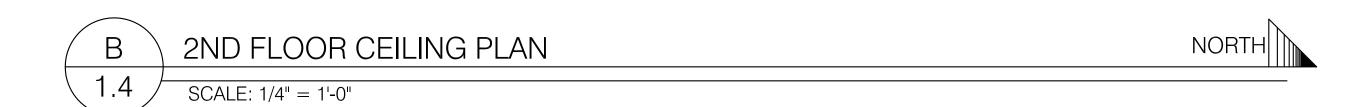
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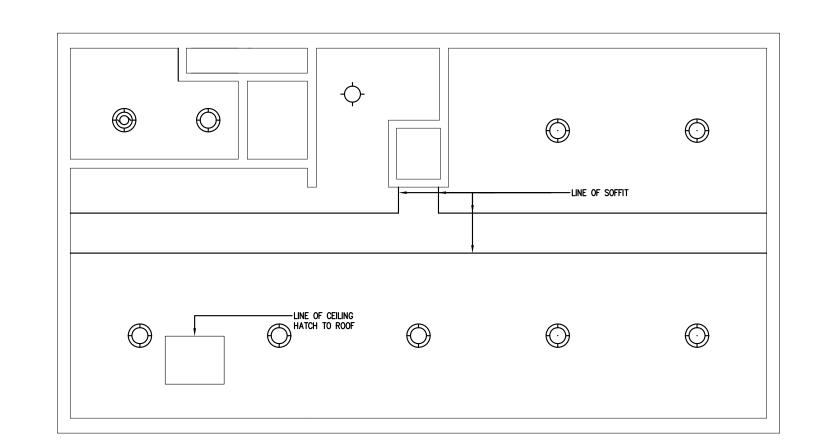






SCALE: 1/4" = 1'-0"



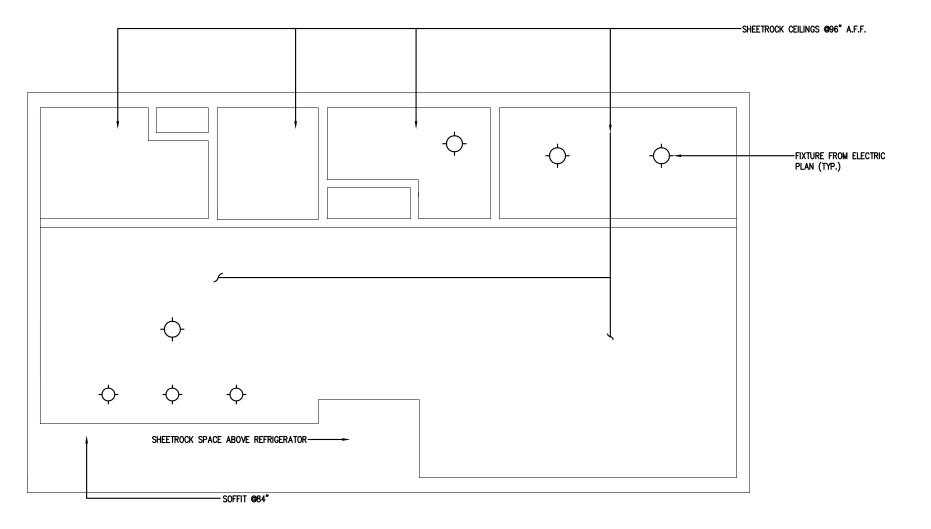




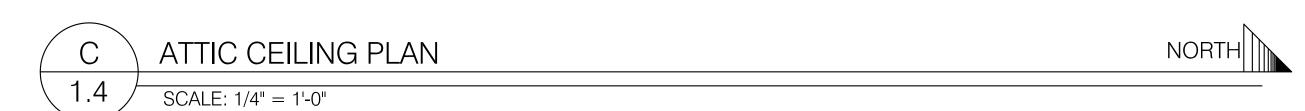

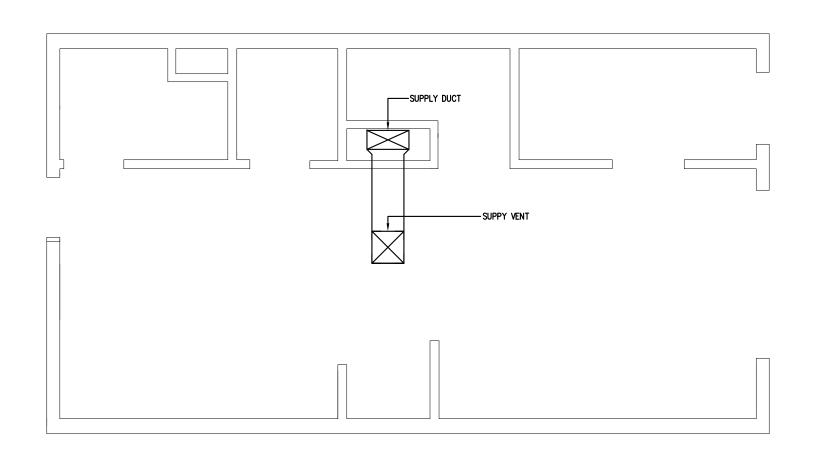


D FIRST FLOOR REGISTER PLAN

1.4 SCALE: 1/4" = 1'-0"

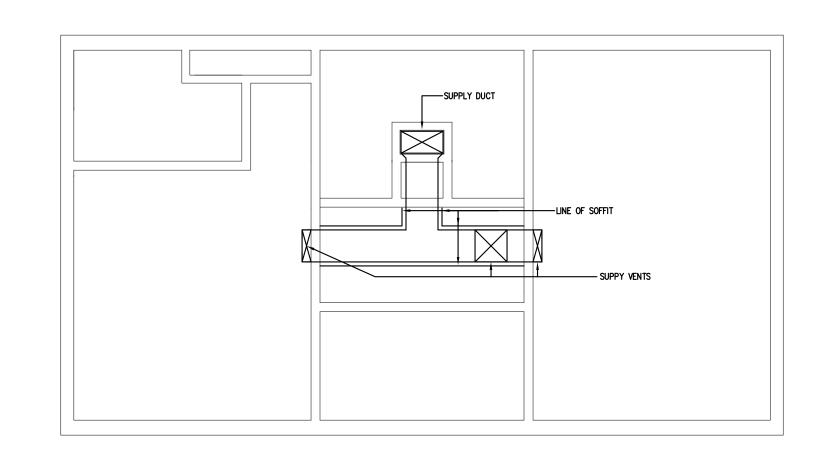

E 2ND FLOOR REGISTER PLAN

1.4 SCALE: 1/4" = 1'-0"

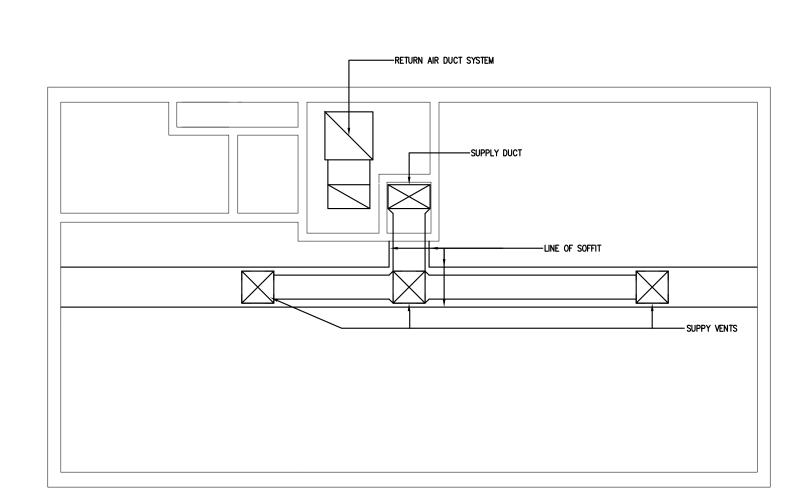


F ATTIC REGISTER PLAN

4 SCALE: 1/4" = 1'-0"




SENIUK RESIDENGE 528 TITAN STRET PHILADELPHIA, PA 1914

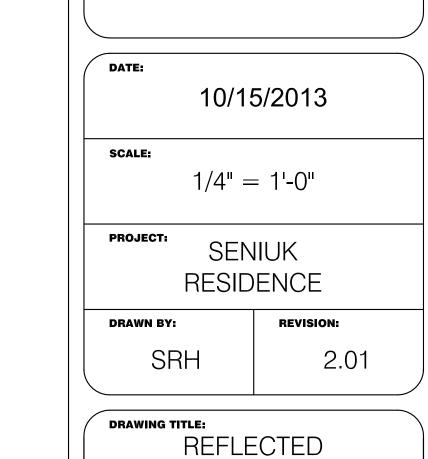

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CEILING PLAN




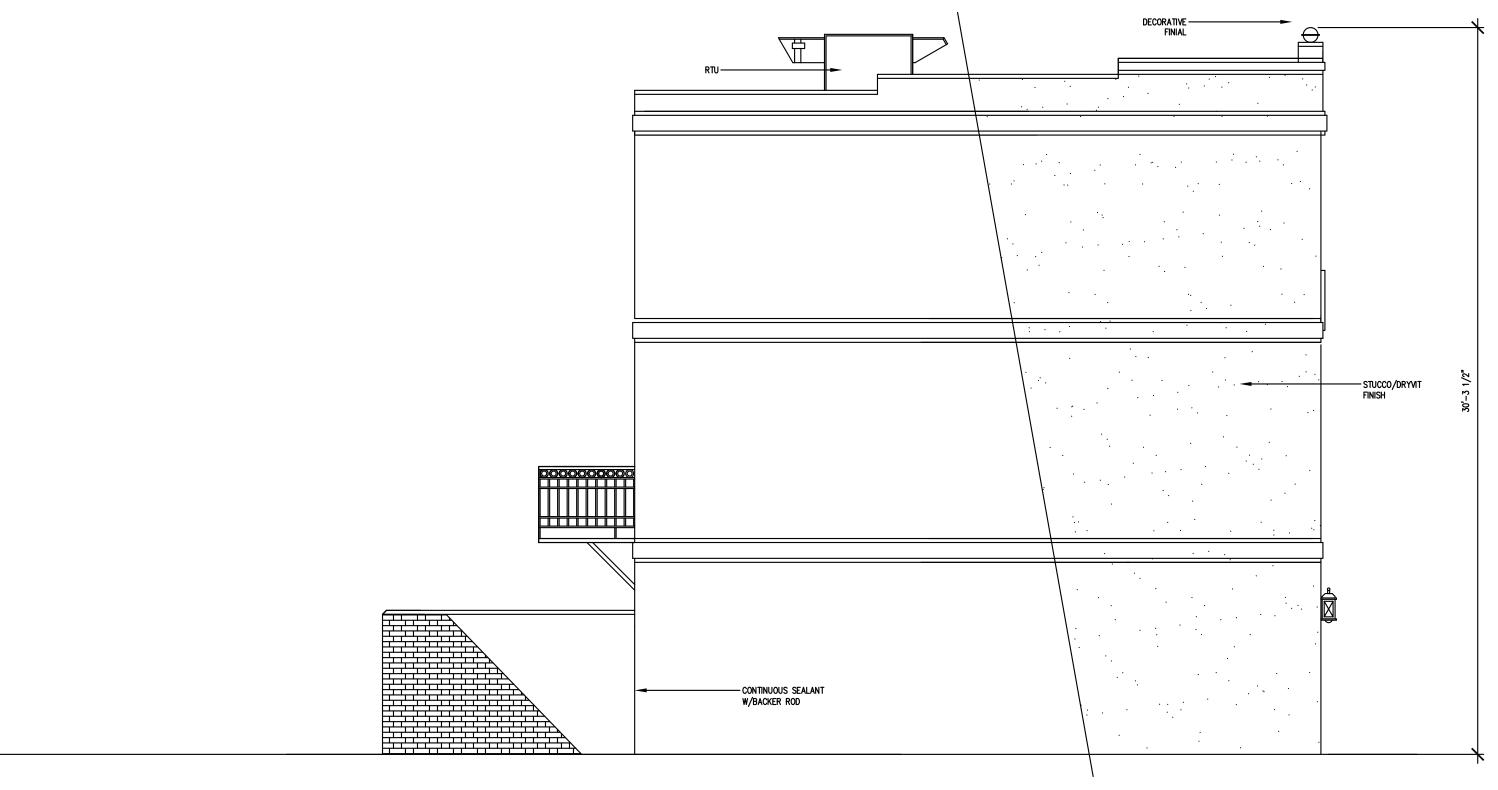

NORTH ELEVATION A-2.0 | SCALE: 1/4" = 1'-0"

A-2.0 | SCALE: 1/4" = 1'-0"

EAST ELEVATION

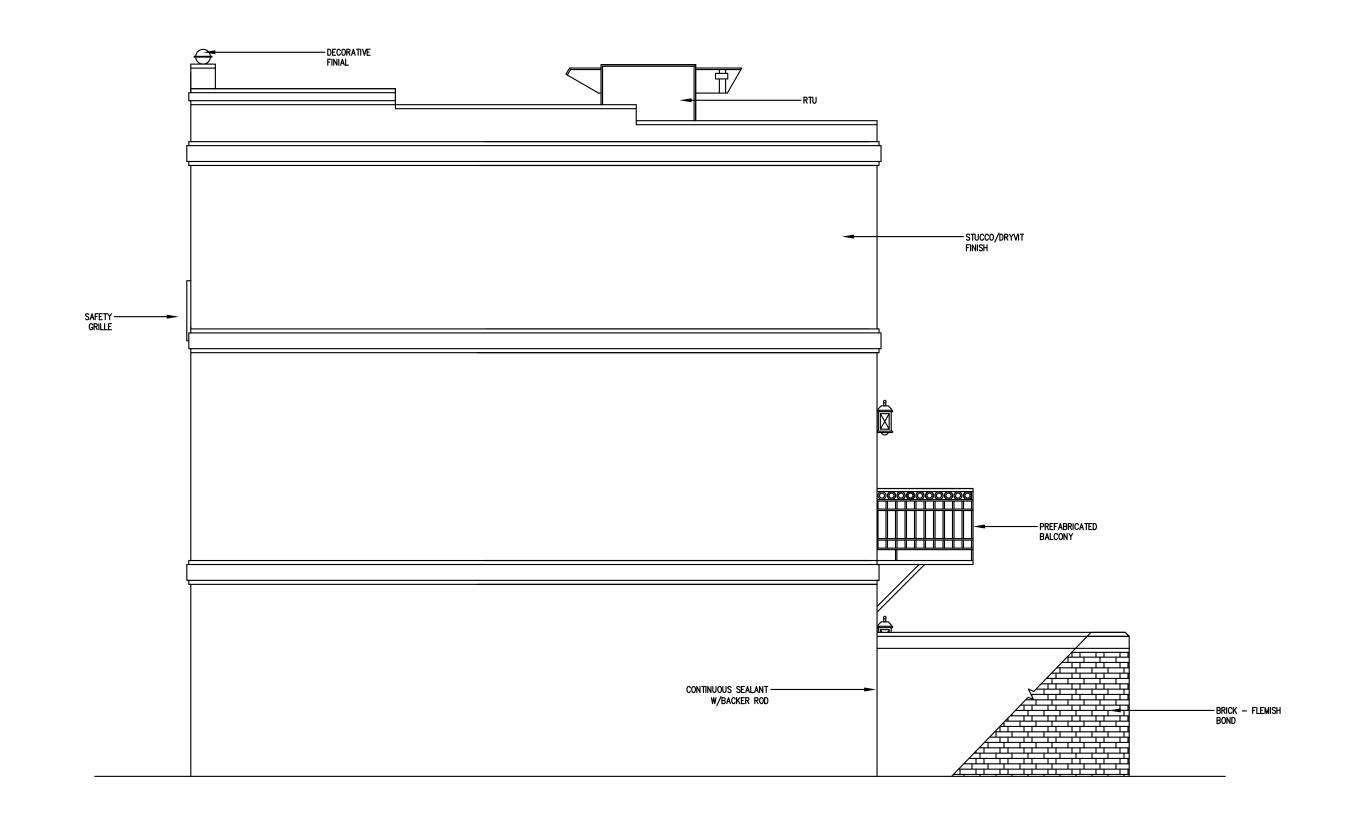



SOUTH ELEVATION A-2.0 | SCALE: 1/4" = 1'-0"

WEST ELEVATION A-2.0 | SCALE: 1/4" = 1'-0"


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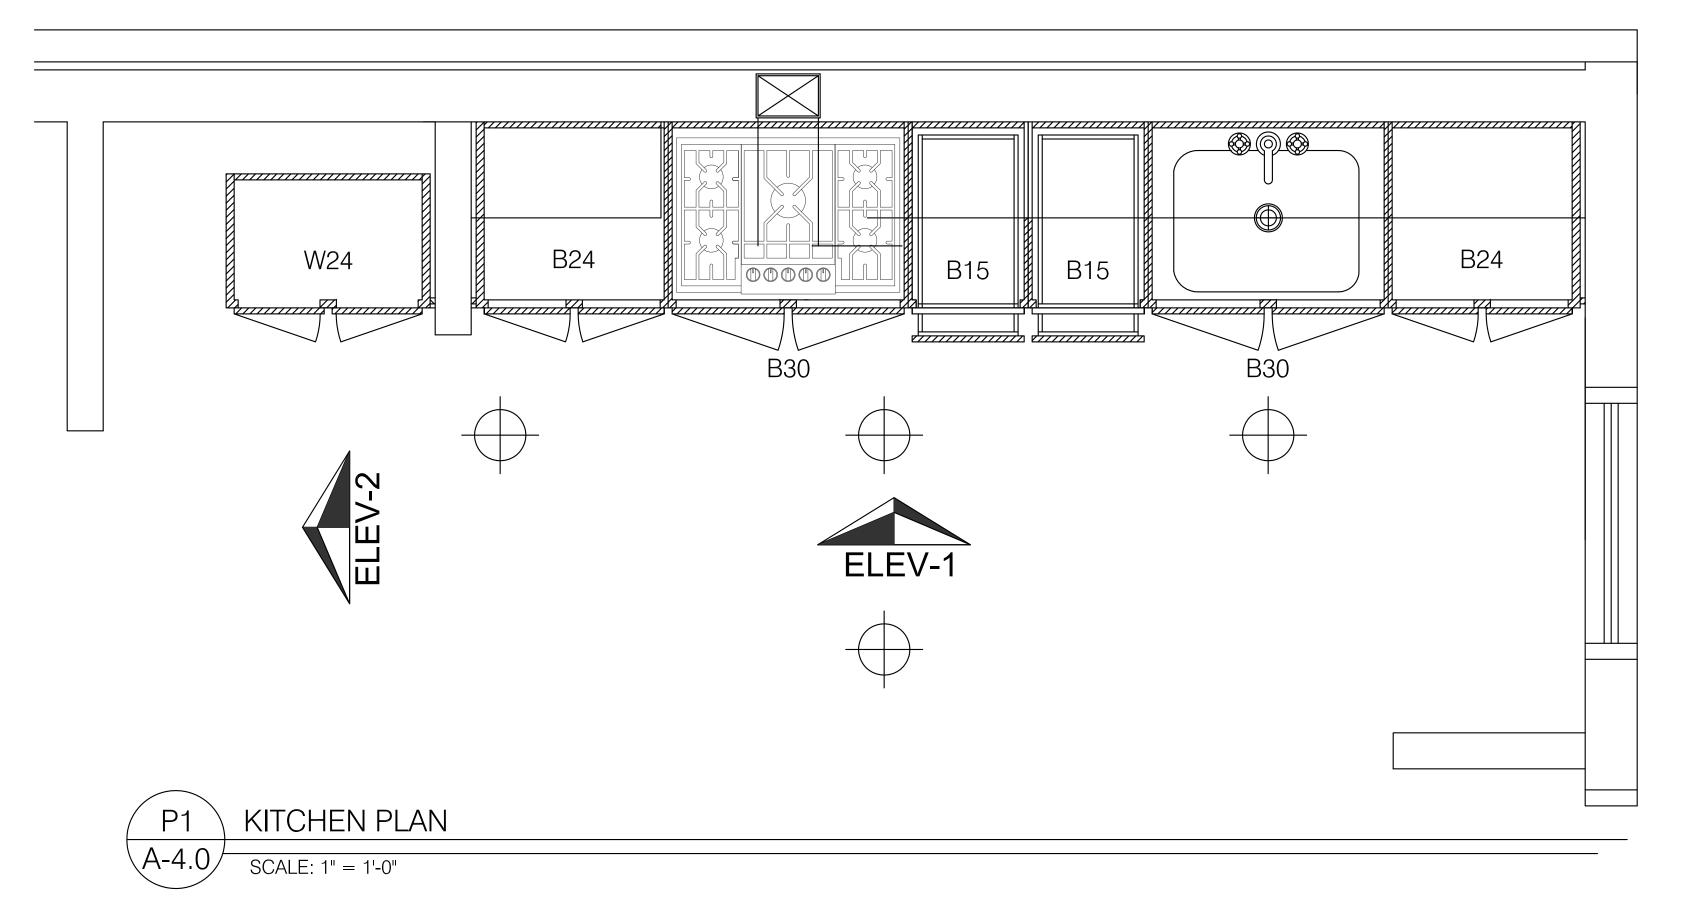
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10/15/2013 1/4" = 1'-0" PROJECT: SENIUK RESIDENCE **REVISION:** 2.01

> **EXTERIOR** ELEVATIONS





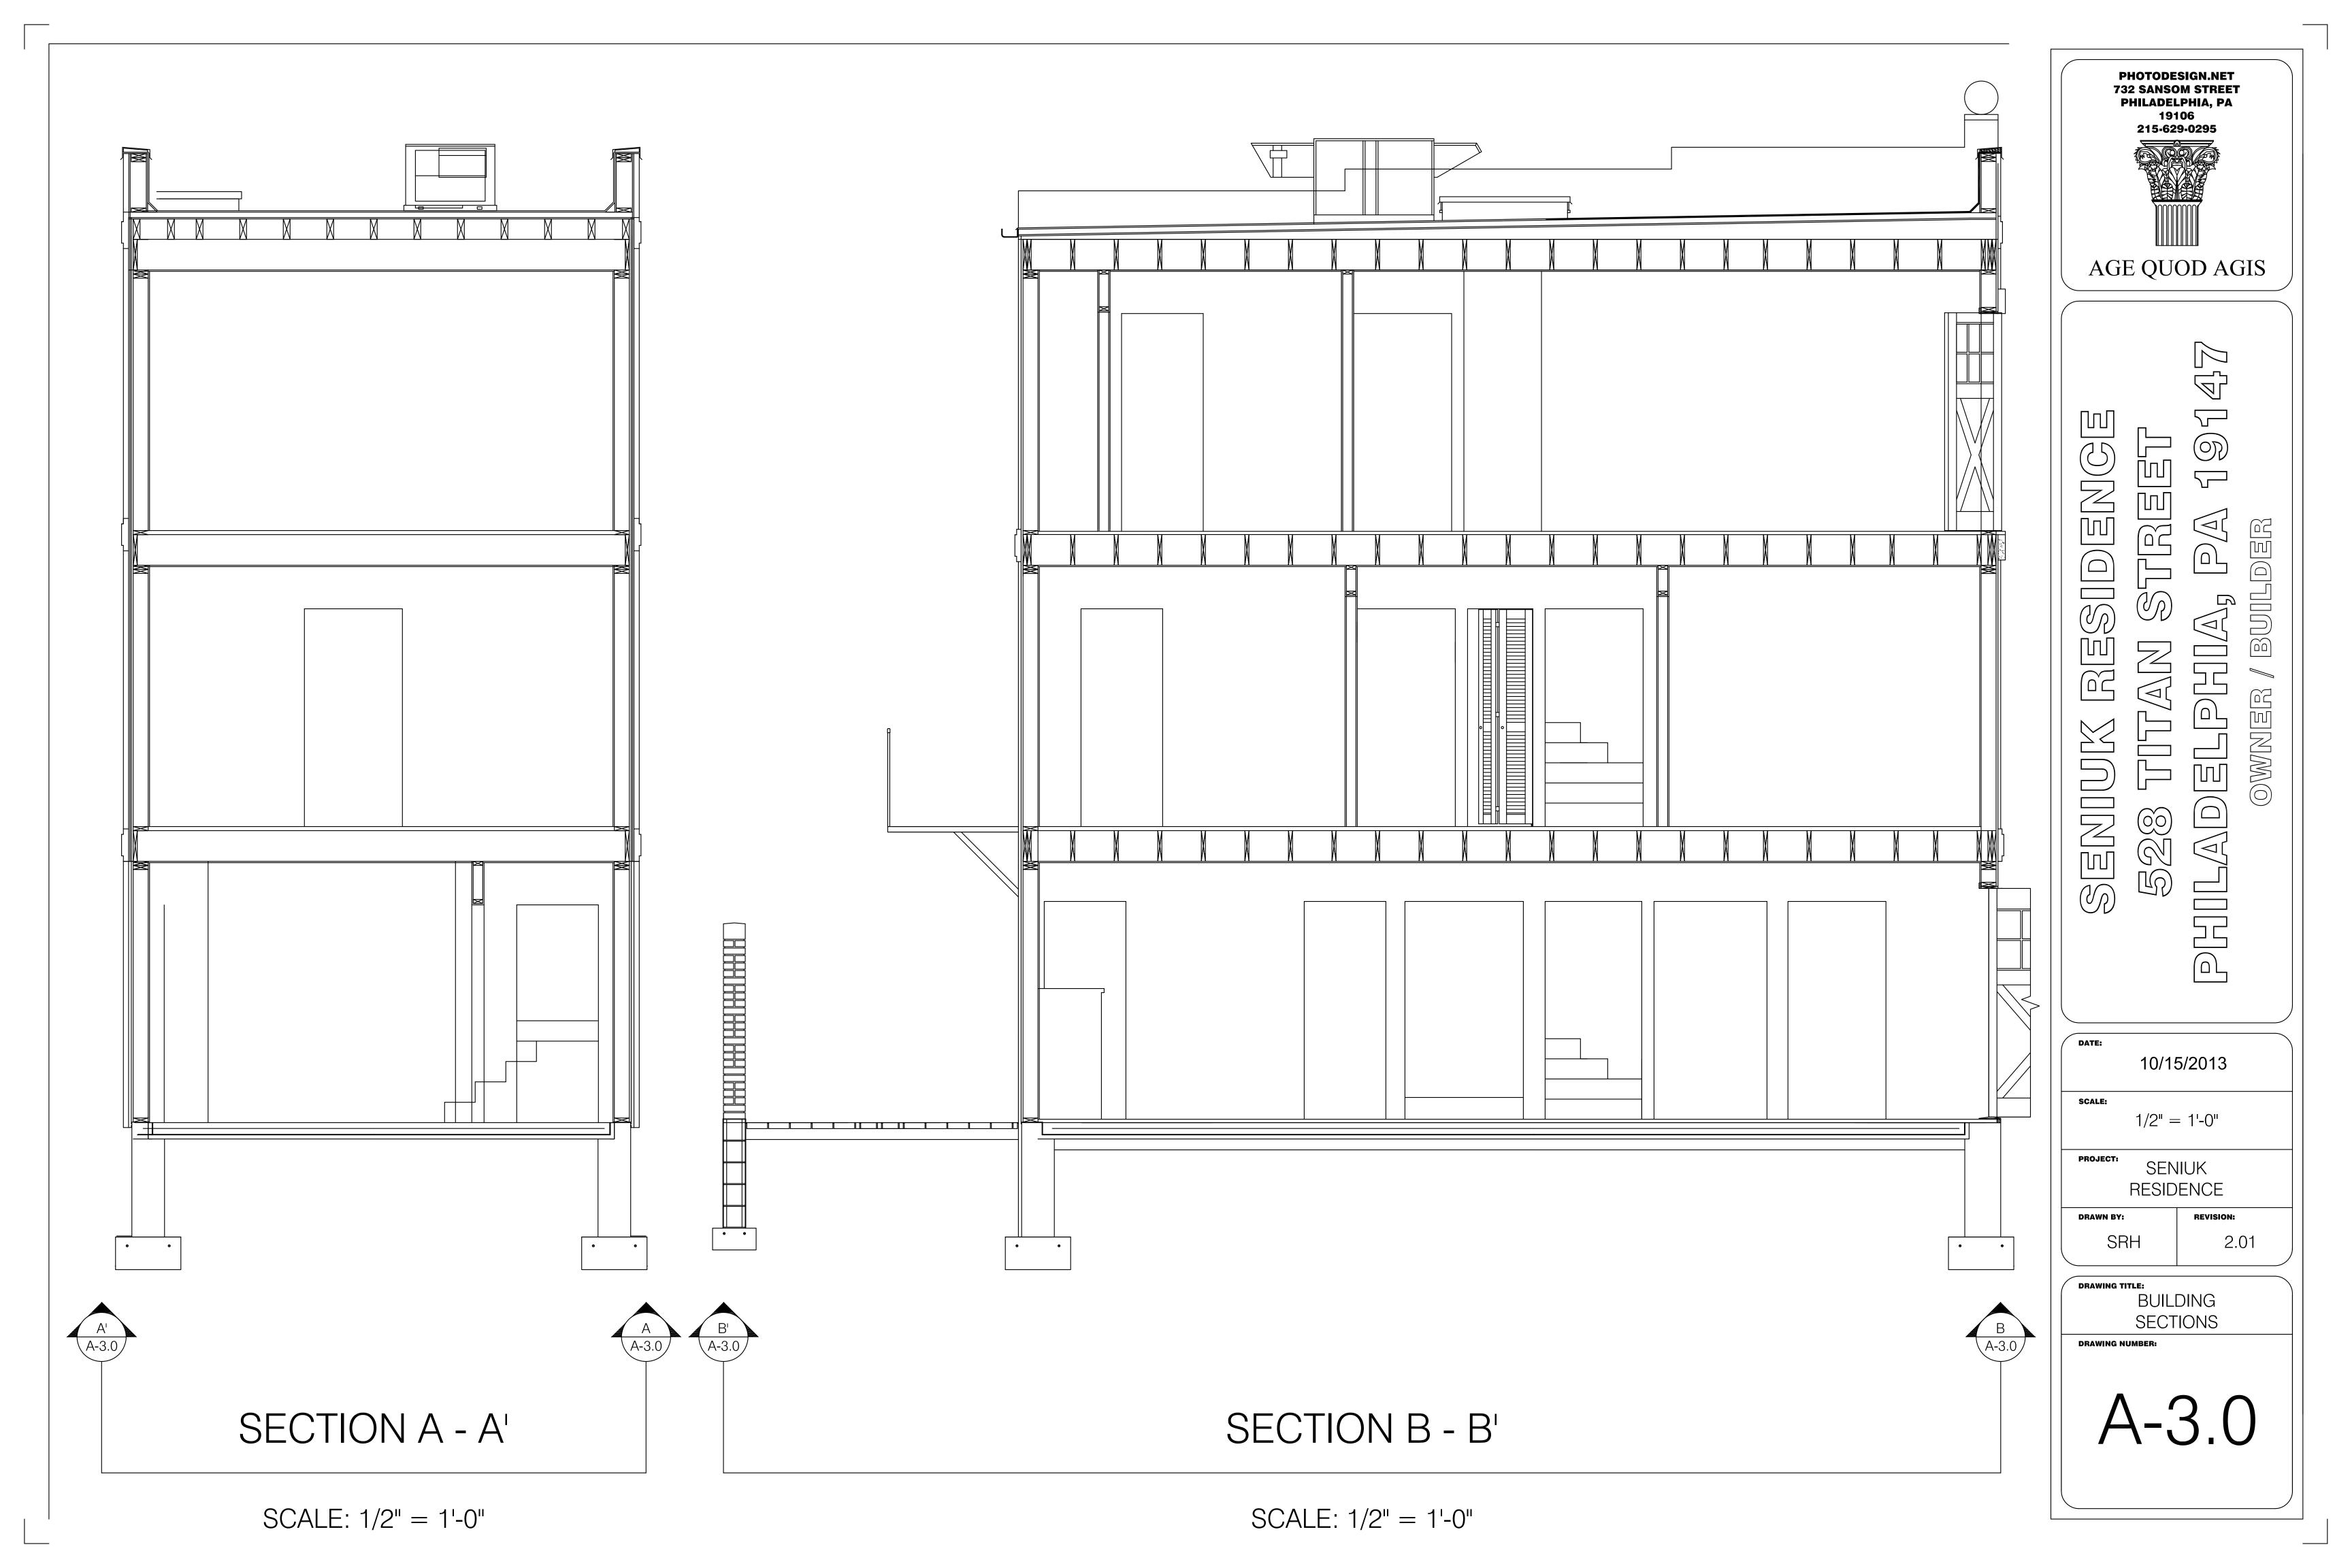


KITCHEN ELEVATION

A-4.0 | SCALE: 1" = 1'-0"

KITCHEN NOTES

- 1. SEE DRAWING E-1.0 FOR ELECTRIC FIXTURES, HARDWARE AND WIRING DIAGRAMS.
- 2. SEE DRAWING P-1.0 FOR PLUMBING DIAGRAMS.
- 3. CABINET DOOR HARDWARE: HAEFELE A-SERIES 110 DEGREE HINGE ARM W/CAM ADJUST, FULL OVERLAY SCREW MOUNT 311.60.500
- 4. DRAWER BOXES: HAEFELE MAPLE, PREFINISHED 5/8" MAPLE PLY, 1/4" DOVETAIL BULLNOSE B.25860.
- **5. DRAWER SLIDES: HAEFELE** 550 (21 5/8") 553.56.206.
- 6. DRAWER & DOOR PULLS TO BE PROVIDED BY OWNER.
- 7. EXISTING REFRIGERATOR TO BE PROVIDED BY OWNER.
- 8. STOVETOP: BOSCH 800 SERIES 30-in 5-BURNER GAS COOKTOP MODEL #: NGM8054UC
- 9. UNDERMOUNT KITCHEN SINK TO BE PROVIDED BY OWNER. MODEL TO BE COMPARABLE TO KRAUS 16-GAUGE SINGLE-BASIN STAINLESS STEEL KITCHEN SINK MODEL #: KHU100-30

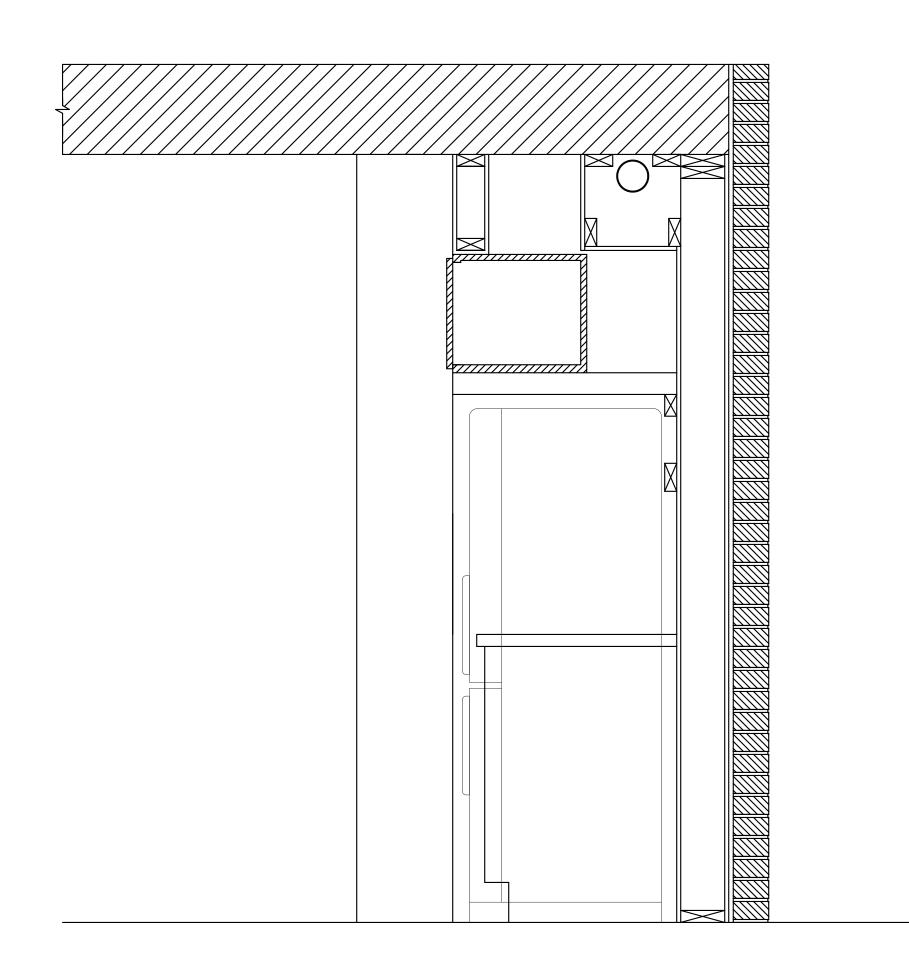



A-4.0 | SCALE: 1/4" = 1'-0"



SENIUM KIESIIDENGE 528 TITAN STREET PHILADELPHIA, PA 191

DATE:

10/15/2013

SCALE:

1/4" = 1'-0"

PROJECT: SENIUK
RESIDENCE


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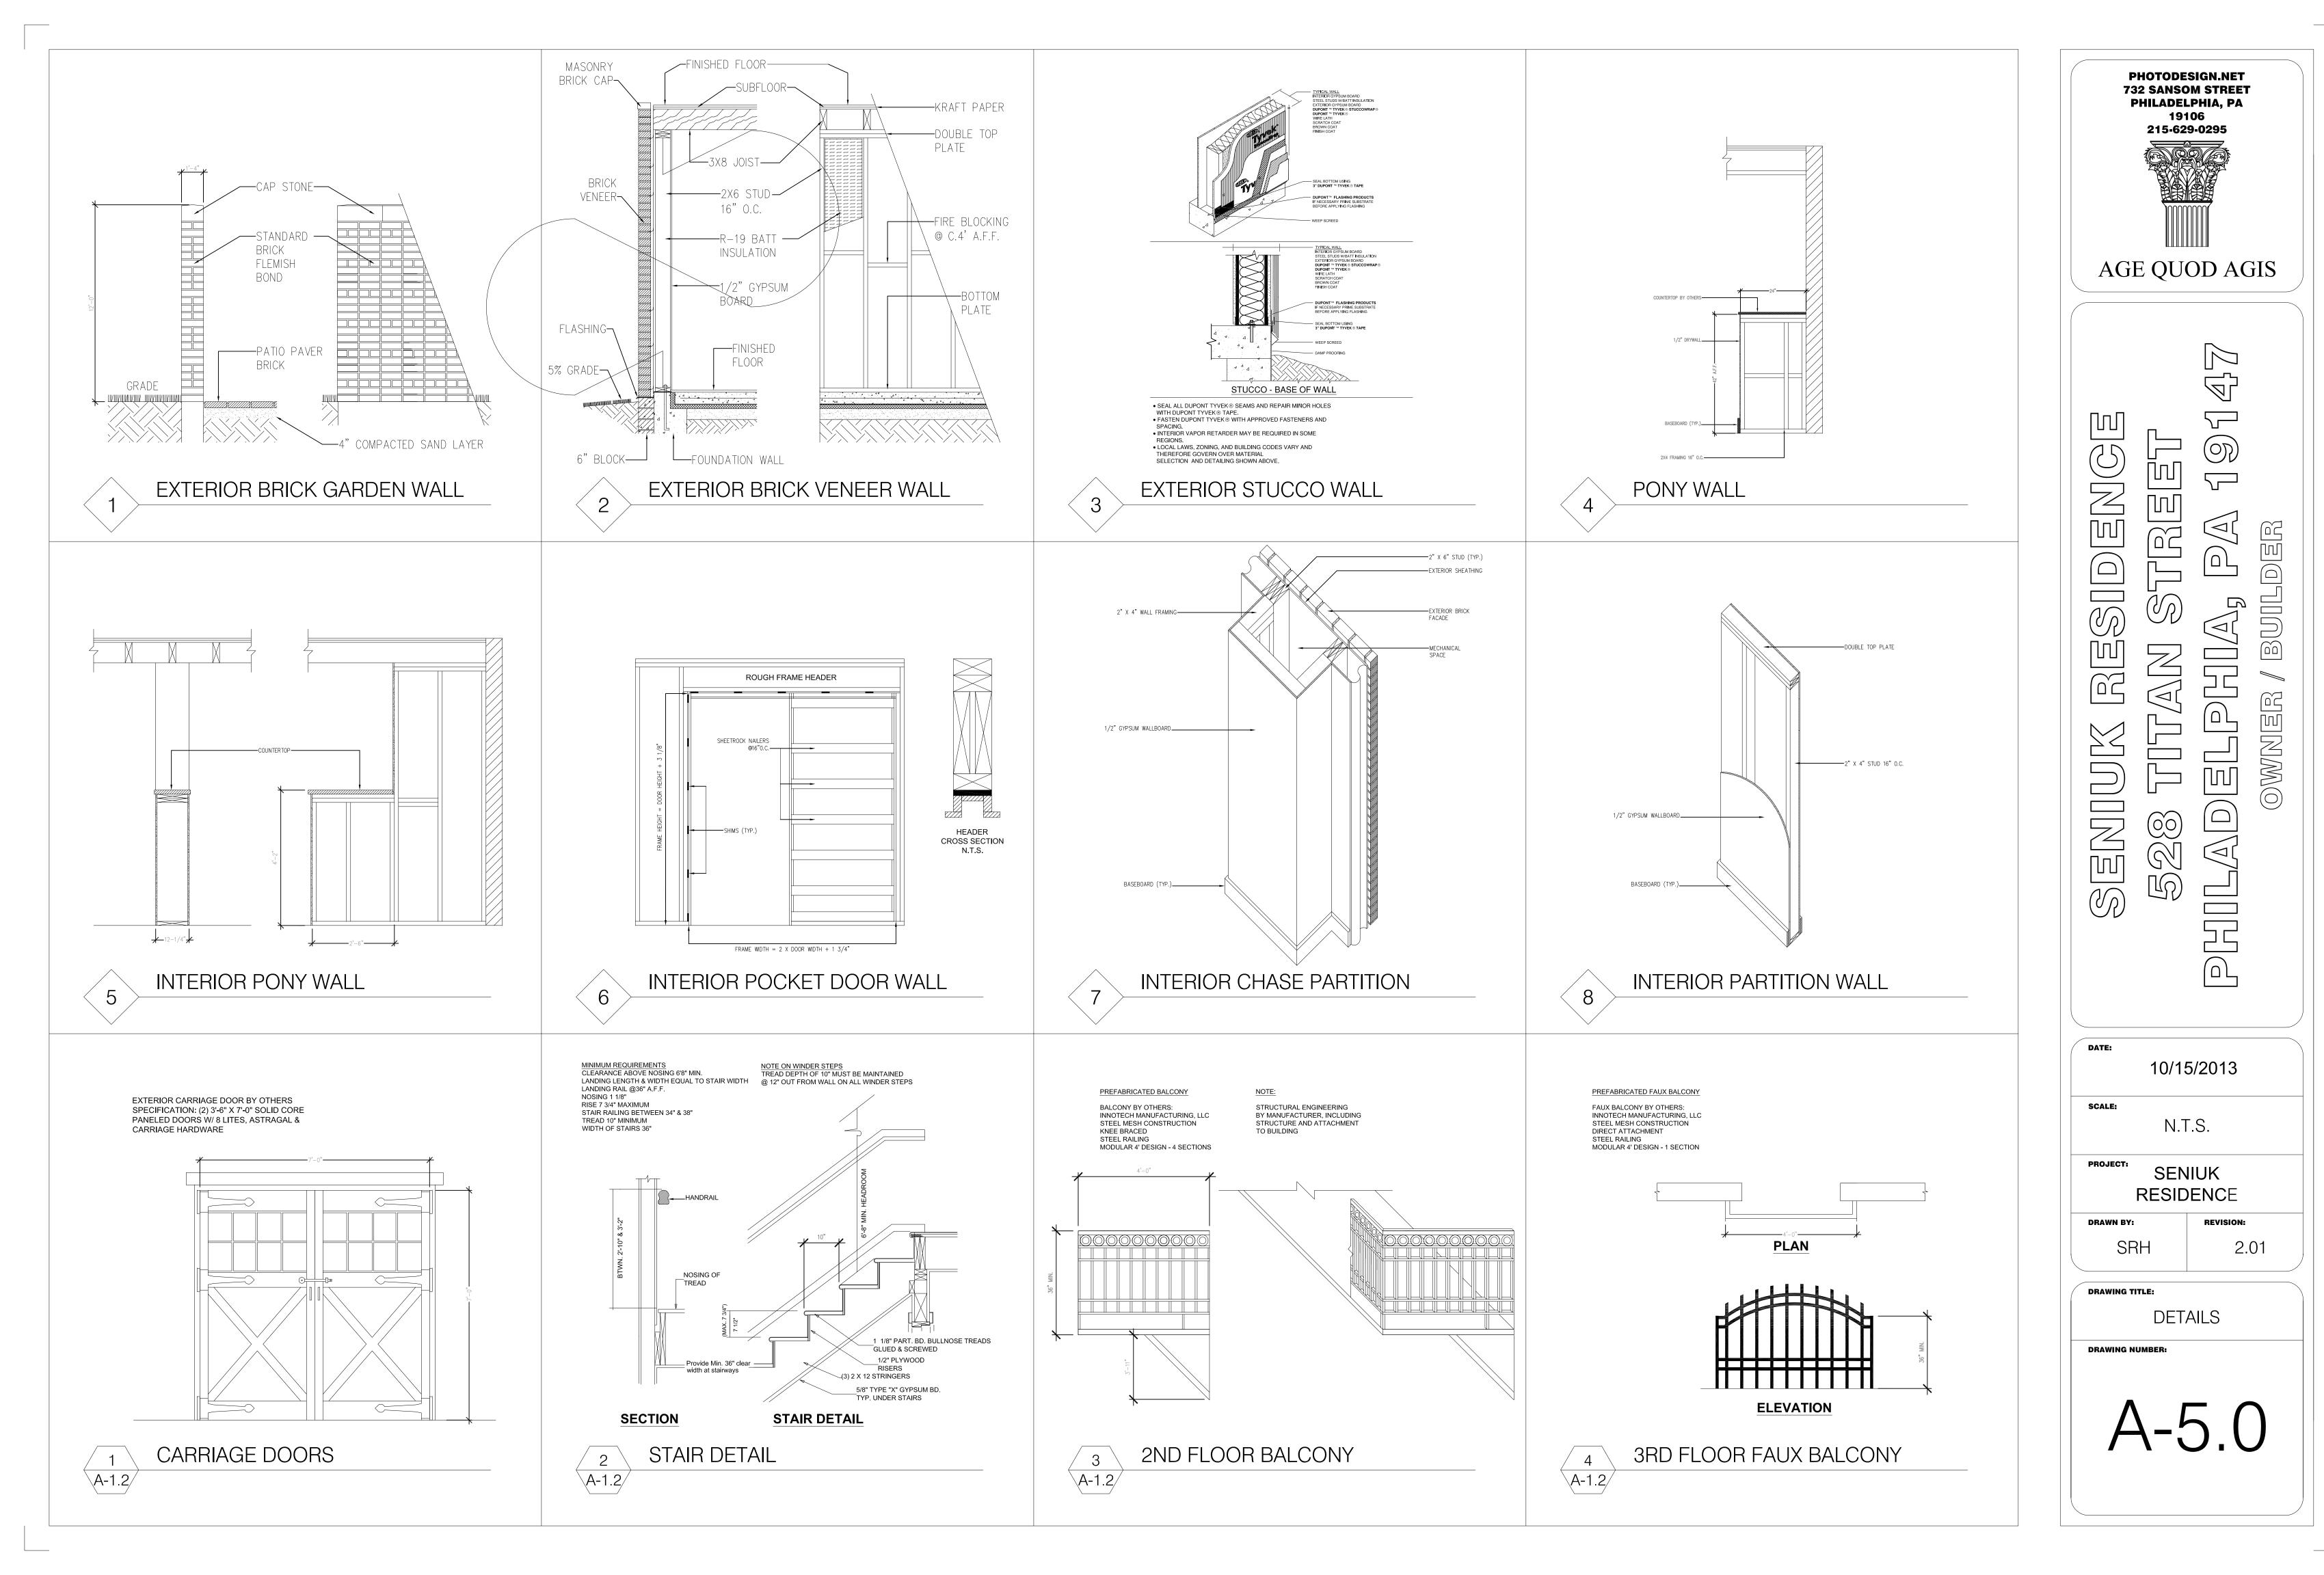
SRH 2.01

KITCHEN PLAN &
SCHEDULES

DRAWING NUMBER:

A-4.0



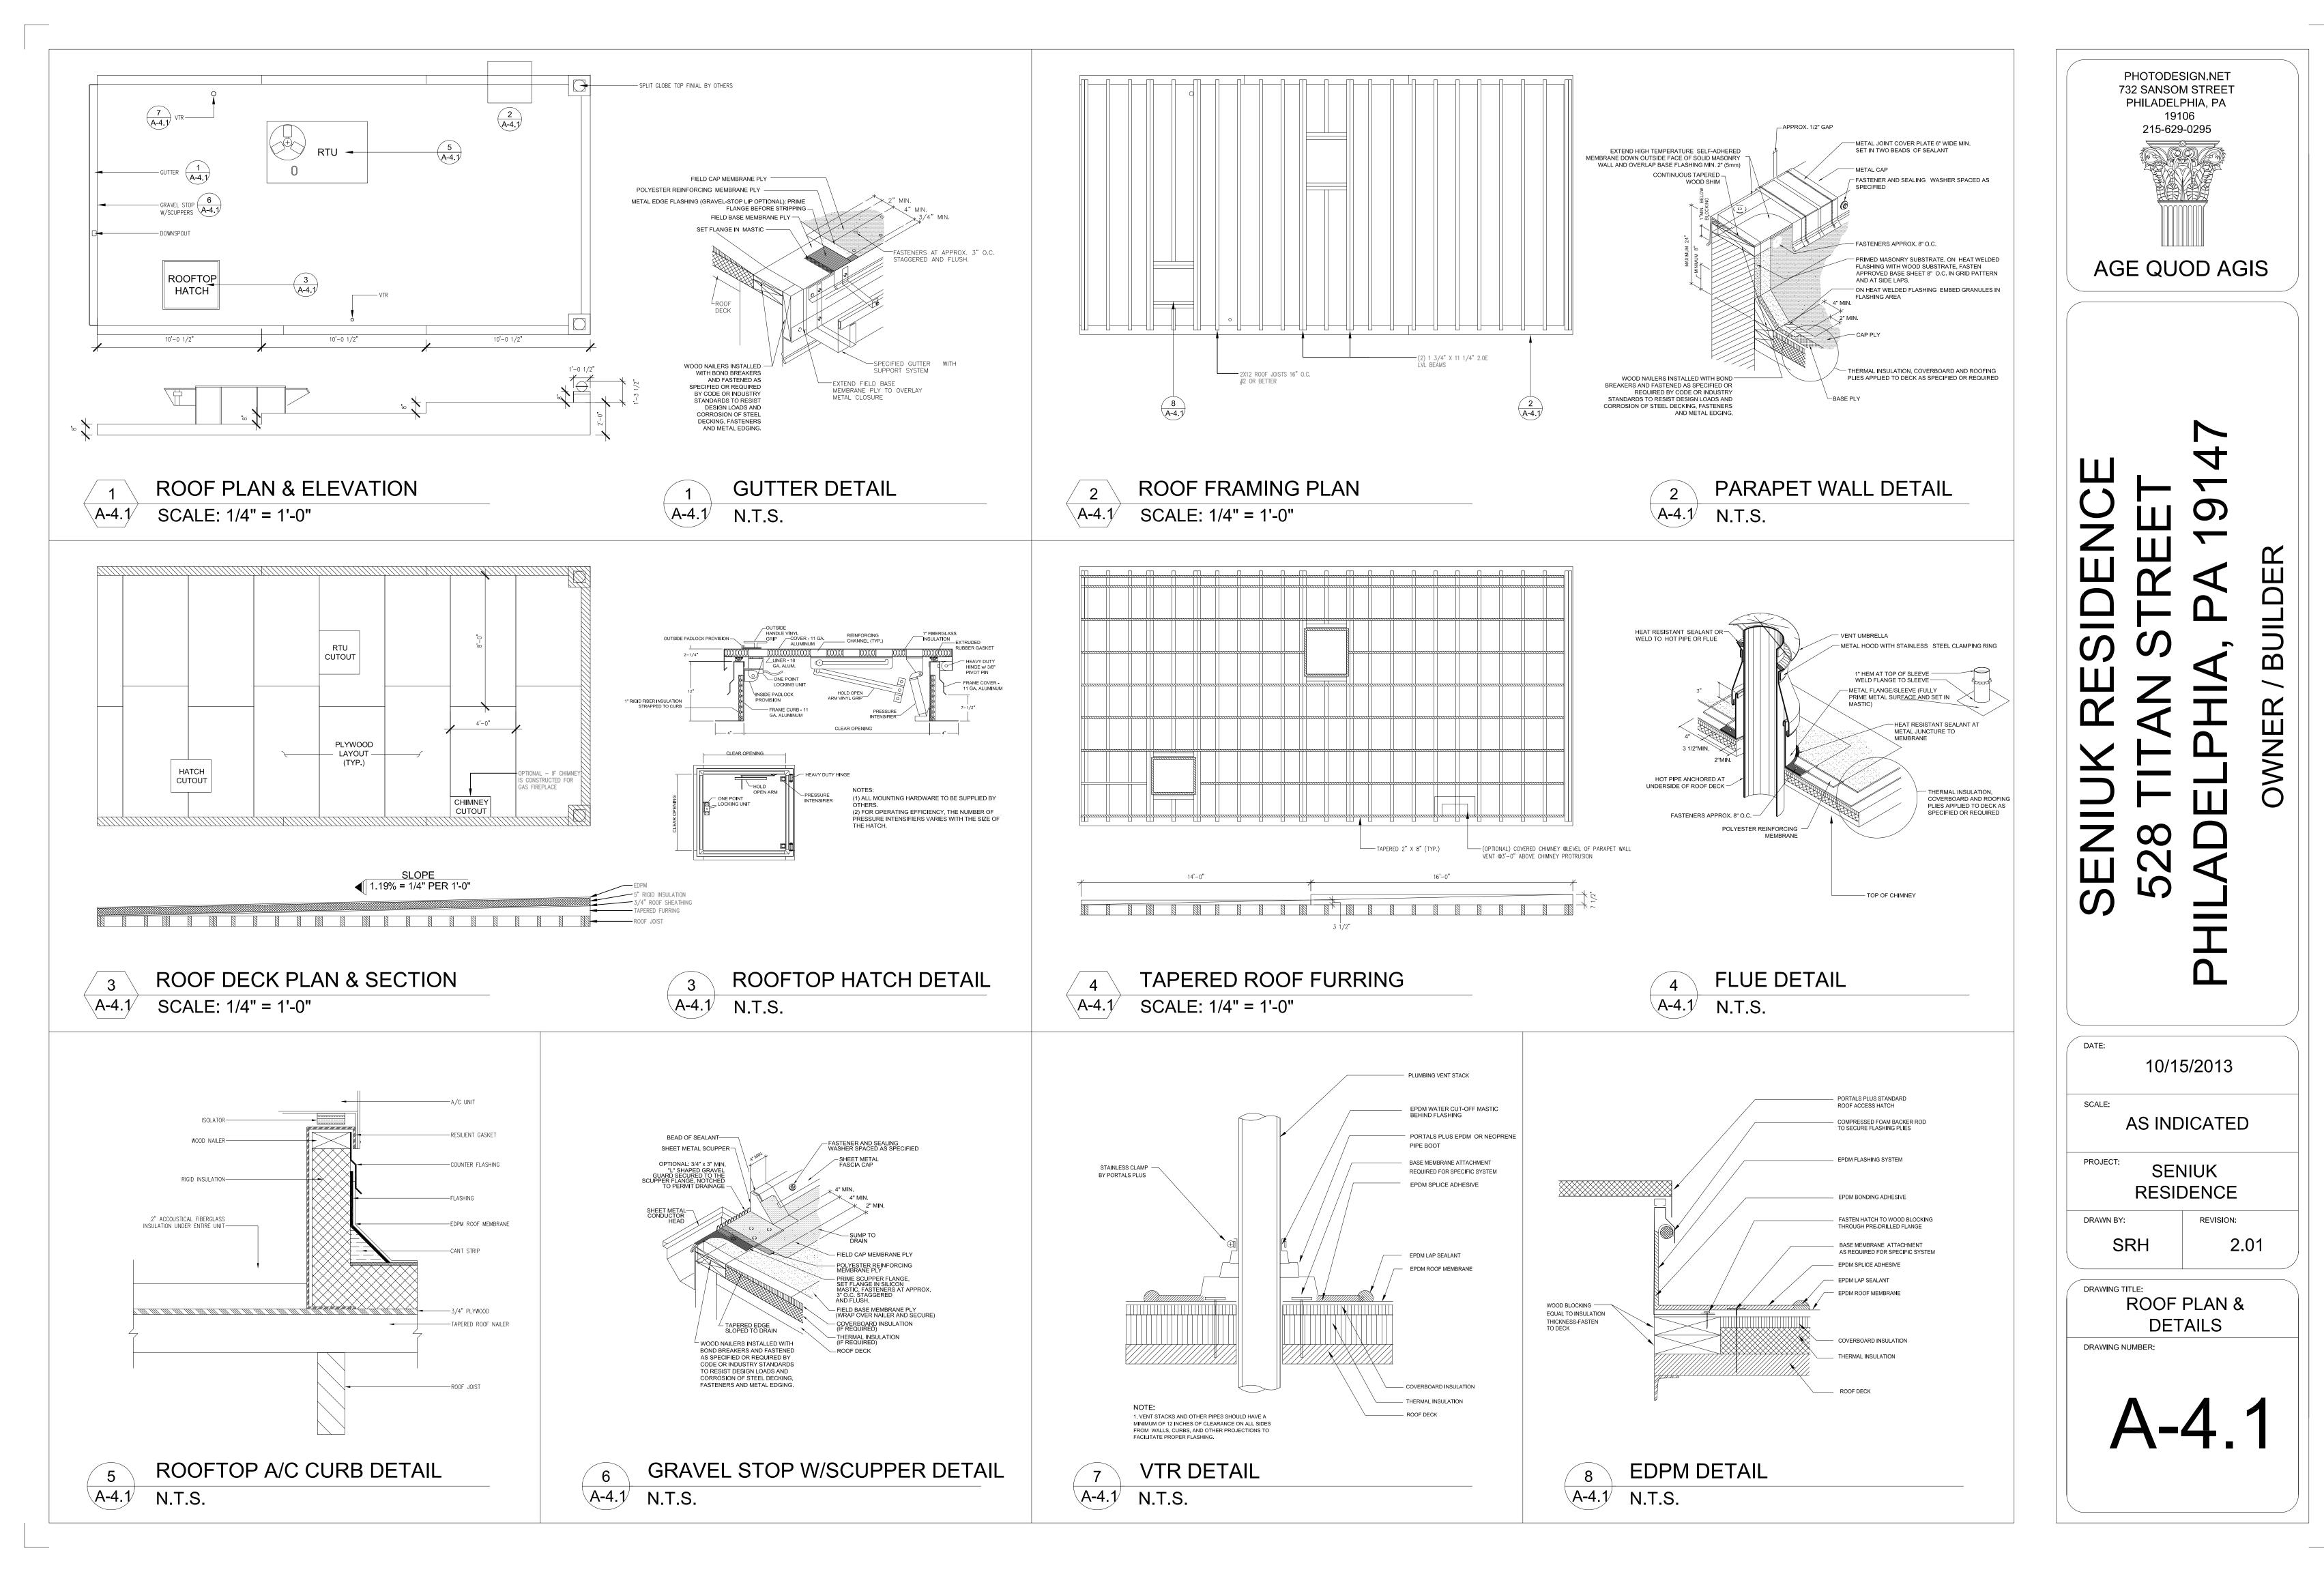

	FINISH SCHEDULES										
ROOM NO.	ROOM NAME	FLOOR FINISH	WALL FINISH	TRIM	CEILING FINISH	CEILING HEIGHT	COMMENTS				
101	ENTRANCE HALLWAY	URETHANE	PAINT	BASE & CEILING	DRYWALL	8'-0"	R.L. COLSTON UTILITY OAK FLOORING 3/4" X 2 1/4" RANDOM LENGTH				
102	ENTRY CLOSET	URETHANE	PAINT	BASE & CEILING	DRYWALL	8'-0"	R.L. COLSTON UTILITY OAK FLOORING 3/4" X 2 1/4" RANDOM LENGTH				
103	PARLOR	URETHANE	PAINT	BASE & CEILING	OPEN BEAM	8'-0"	R.L. COLSTON UTILITY OAK FLOORING 3/4" X 2 1/4" RANDOM LENGTH				
104	KITCHEN	URETHANE	PAINT & TILE	BASE & CEILING	OPEN BEAM	8'-0"	R.L. COLSTON UTILITY OAK FLOORING 3/4" X 2 1/4" RANDOM LENGTH				
105	PANTRY	URETHANE	PAINT	BASE & CEILING	OPEN BEAM	8'-0"	R.L. COLSTON UTILITY OAK FLOORING 3/4" X 2 1/4" RANDOM LENGTH				
106	BATHROOM	CERAMIC TILE	PAINT & TILE	BASE & CEILING	DRYWALL	8'-0"	CERAMIC TILE BY OWNER				
107	PATIO	BRICK	GLAZED	N/A	N/A	6'-0"	PAVERS BY OWNER LAID IN SAND				
108	STAIRWELL	URETHANE	PAINT	BASE & CEILING	DRYWALL	8'-0"	R.L. COLSTON UTILITY OAK FLOORING 3/4" X 2 1/4" RANDOM LENGTH				
201	STUDIO	URETHANE	PAINT	BASE & CEILING	DRYWALL	8'-0"	R.L. COLSTON UTILITY OAK FLOORING 3/4" X 2 1/4" RANDOM LENGTH				
202	UTILITY	VCT TILE	PAINT & TILE	BASE & CEILING	DRYWALL	8'-0"	VCT TILE BY OWNER				
203	CLOSET	URETHANE	PAINT	BASE & CEILING	DRYWALL	8'-0"	R.L. COLSTON UTILITY OAK FLOORING 3/4" X 2 1/4" RANDOM LENGTH				
204	BEDROOM	URETHANE	PAINT	BASE & CEILING	OPEN BEAM	8'-0"	R.L. COLSTON UTILITY OAK FLOORING 3/4" X 2 1/4" RANDOM LENGTH				
205	BATHROOM	CERAMIC TILE	PAINT & TILE	BASE & CEILING	DRYWALL	8'-0"	CERAMIC TILE BY OWNER				
206	BALCONY	METAL	METAL	N/A	N/A	3'-0"	PREFINISHED MODULAR BALCONY BY OTHERS				
207	STAIRWELL	URETHANE	PAINT	BASE & CEILING	DRYWALL	8'-0"	R.L. COLSTON UTILITY OAK FLOORING 3/4" X 2 1/4" RANDOM LENGTH				
301	STORAGE LOFT	URETHANE	PAINT	BASE & CEILING	DRYWALL	8'-0"	R.L. COLSTON UTILITY OAK FLOORING 3/4" X 2 1/4" RANDOM LENGTH				
302	BATHROOM	CERAMIC TILE	PAINT & TILE	BASE & CEILING	DRYWALL	8'-0"	CERAMIC TILE BY OWNER				
303	FURNACE ROOM	VCT TILE	PAINT	BASE & CEILING	DRYWALL	8'-0"	VCT TILE BY OWNER				
304	HALLWAY	URETHANE	PAINT	BASE & CEILING	DRYWALL	8'-0"	R.L. COLSTON UTILITY OAK FLOORING 3/4" X 2 1/4" RANDOM LENGTH				

DOOR SCHEDULE										
SYMBOLS	DESCRIPTION	TYPE	WIDTH	HEIGHT	HARDWARE	COUNT	COMMENTS			
(101)	CARRIAGE DOORS	SC W/ 8 LITE GLAZING	3'-6"	7'-0"	BLACK STRAP IRON HINGES & CLASPS	2	EXTERIOR DOORS BY OTHERS			
102 106 206 301	CUSTOM FRONT DOOR	SC W/ 8 LITE GLAZING	3'-0"	7'-0"	BLACK STRAP IRON HINGES & CLASPS	4	EXTERIOR DOORS BY OTHERS			
103	LOUVERED BIFOLD DOOR	SC - WOOD	2'-6", 3'-0"	6'-8"	BRUSHED BRONZE PASSAGE	2	NATURAL WOOD FINISH			
104)	SIX PANEL-POCKET	SC - WOOD	3'-0"	6'-8"	BRUSHED BRONZE PASSAGE	1	NATURAL WOOD FINISH			
105 (106) (205)	POCKET DOOR	SC - WOOD	2'-6"	6'-8"	BRUSHED BRONZE PRIVACY	4	NATURAL WOOD FINISH			
201) 204) 305)	SIX PANEL	SC - WOOD	3'-0"	6'-8"	BRUSHED BRONZE PRIVACY (1) LOCKSET (1)	2	NATURAL WOOD FINISH			
202	LOUVERED BIFOLD DOOR	SC - WOOD	2'-6"	6'-8"	BRUSHED BRONZE PASSAGE	1	NATURAL WOOD FINISH			
203	LOUVERED DOORS	SC - WOOD	2'-6"	6'-8"	BRUSHED BRONZE PASSAGE	2	NATURAL WOOD FINISH			
207)	LOUVERED BIFOLD DOOR	SC - WOOD	2'-6"	6'-8"	BRUSHED BRONZE PASSAGE		NATURAL WOOD FINISH			

WINDOW SCHEDULE									
SYMBOLS	DESCRIPTION	TYPE	WIDTH	HEIGHT	FRAME	COUNT	COMMENTS		
301	SINGLE HUNG	METAL CLAD	2'-6"	4'-0"	BRUSHED BRONZE	11	LOW E DOUBLE GLAZED W/ WEATHER SEAL		

PAINT SCHEDULE									
ROOM NO. COLOR DESCRIPTION		DESCRIPTION	COMMENTS						
101	ANTIQUE WHITE	SATIN ON WALLS SEMI-GLOSS ON TRIM	SHERWIN WILLIAMS SW6119						
102	ANTIQUE WHITE	SATIN ON WALLS SEMI-GLOSS ON TRIM	SHERWIN WILLIAMS SW6119						
103	COLOR BY OWNER	SATIN ON WALLS SEMI-GLOSS ON TRIM	SHERWIN WILLIAMS						
104	COLOR BY OWNER	SATIN ON WALLS SEMI-GLOSS ON TRIM	SHERWIN WILLIAMS						
105	ANTIQUE WHITE	SATIN ON WALLS SEMI-GLOSS ON TRIM	SHERWIN WILLIAMS SW6119						
106	COLOR BY OWNER	SATIN ON WALLS SEMI-GLOSS ON TRIM	SHERWIN WILLIAMS						
107	N/A	N/A	N/A						
108	ANTIQUE WHITE	SATIN ON WALLS SEMI-GLOSS ON TRIM	SHERWIN WILLIAMS SW6119						
201	ANTIQUE WHITE	SATIN ON WALLS SEMI-GLOSS ON TRIM	SHERWIN WILLIAMS SW6119						
202	ANTIQUE WHITE	SEMI-GLOSS ON WALLS SEMI-GLOSS ON TRIM	SHERWIN WILLIAMS SW6119						
203	ANTIQUE WHITE	SATIN ON WALLS SEMI-GLOSS ON TRIM	SHERWIN WILLIAMS SW6119						
204	COLOR BY OWNER	SATIN ON WALLS SEMI-GLOSS ON TRIM	SHERWIN WILLIAMS						
205	COLOR BY OWNER	SATIN ON WALLS SEMI-GLOSS ON TRIM	SHERWIN WILLIAMS						
206	PREFINISHED BLACK	BAKED ENAMEL	BY OTHERS						
207	ANTIQUE WHITE	SATIN ON WALLS SEMI-GLOSS ON TRIM	SHERWIN WILLIAMS SW6119						
301	ANTIQUE WHITE	SATIN ON WALLS SEMI-GLOSS ON TRIM	SHERWIN WILLIAMS SW6119						
302	COLOR BY OWNER	SATIN ON WALLS SEMI-GLOSS ON TRIM	SHERWIN WILLIAMS						
303	ANTIQUE WHITE	SEMI-GLOSS ON WALLS SEMI-GLOSS ON TRIM	SHERWIN WILLIAMS SW6119						
304	COLOR BY OWNER	SATIN ON WALLS SEMI-GLOSS ON TRIM	SHERWIN WILLIAMS						

	TRIM SCHEDULE										
ROOM TYPE	DESCRIPTION	BASE	CEILING	COMMENTS							
BATH	BATHROOMS	CERAMIC	WOOD	4" CERAMIC BASE COVE TO MATCH WALL TILE							
UTILITY	UTILITY, FURNACE	VCT	WOOD	4" VCT 1" X 2" WOOD CEILING							
OTHER	ALL OTHER ROOMS	WOOD	WOOD	1"X6" WOOD BASE 1" X 2" WOOD CEILING							

NOTES:

- CABINET FINISH TO BE RESPONSIBILITY OF OWNER.
- 2. PRIME ALL SURFACES PRIOR TO APPLYING FINAL PAINT FINISH.
- 3. ALL SURFACES RECEIVE A FINISH UNLESS NOTED OTHERWISE.
- 4. EXPOSED CONCRETE FLOOR TO RECEIVE 2 COATS OF SEALER.
- 5. PAINT ALL GRILLS, VENTS, PIPING & ETC. TO MATCH ADJACENT FINISH.
- 6. PROVIDE CORNER GUARDS ON ALL EXTERIOR CORNERS.
- 7. ALL EXPOSED MECHANICAL EQUIPMENT TO BE PRIMED AND PAINTED WITH #5205 GRAY METAL PRIMER IF NOT PREFINISHED.
- 8. DOOR FRAMES & TRIM SHALL BE PAINTED WITH SEMIGLOSS ENAMEL



SENIUK RESIDENGE 528 TITAN STREET

DATE:

10/15/2013

SCALE:

N.T.S.

PROJECT: SENIUK
RESIDENCE


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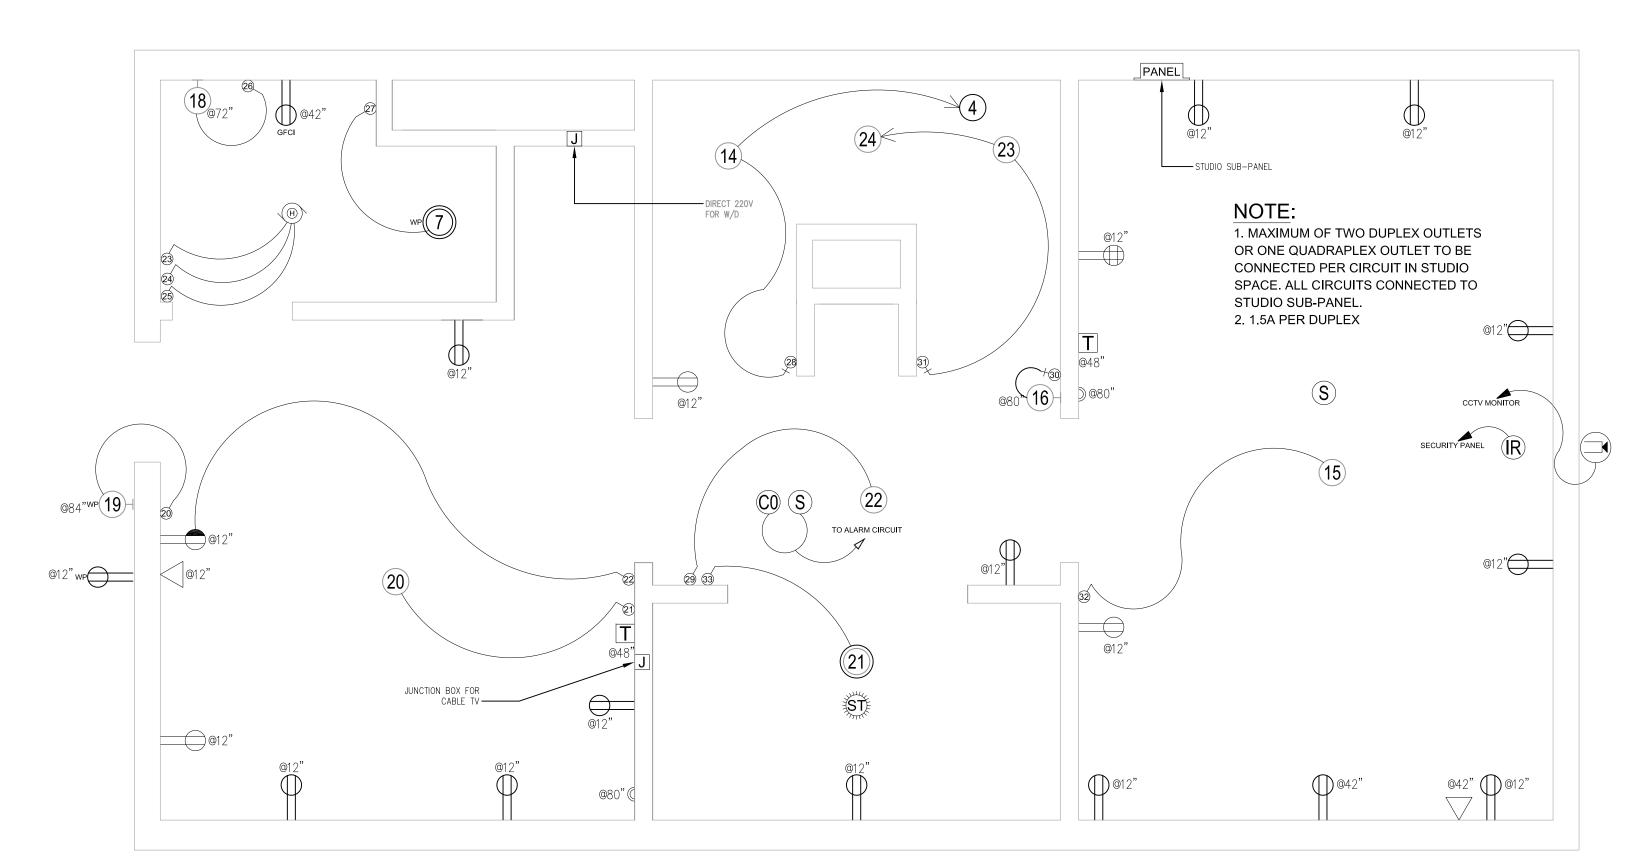
WINDOW, DOOR & FINISH
SCHEDULES

2.01

DRAWING NUMBER:

A-6.0



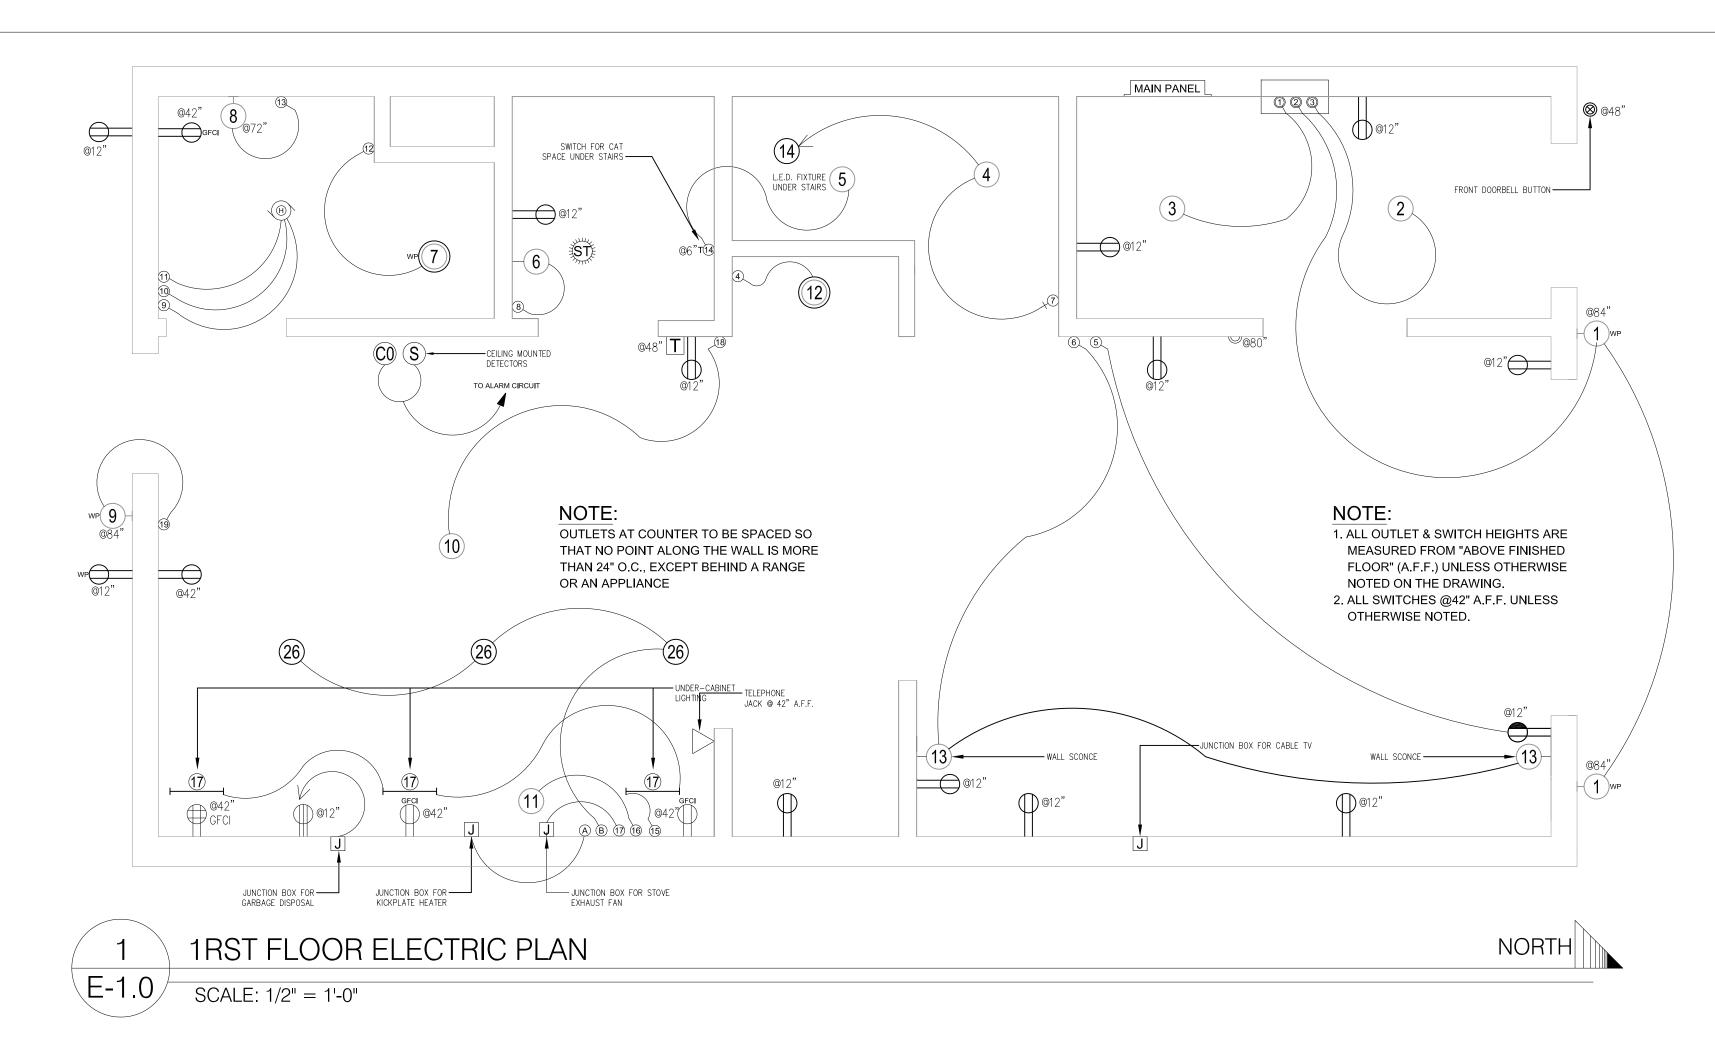

2 2ND FLOOR ELECTRIC PLAN E-1.0 SCALE: 1/2" = 1'-0" ELECTRIC SYMBOLS

	SWITCHING RUN	F	CEILING FAN
\$1	HOME RUN	PANEL	CIRCUIT BREAKER BOX - PANEL
(R)	MOTION DETECTOR	J	JUNCTION BOX
——	SINGLE LAMP FLUOR. FIXTURE		TELEPHONE OUTLET
—	DOUBLE LAMP FLUOR. FIXTURE	L	PERMANENTLY CONNECTED EQUIP.
Н	WALL MOUNTED FLUOR. FIXTURE		FLOOD LIGHT
Ю	WALL MOUNTED LIGHT FIXTURE	Ĺ	LOW VOLTAGE LIGHTING
1	CEILING LIGHT FIXTURE		GLOBE TYPE CCTV CAMERA
Q	SWITCH, SINGLE POLE	ST	SOLATUBE
Ø,	SWITCH, THREE WAY		DUPLEX OUTLET
	ANNUNCIATOR	GFCI	GFCI DUPLEX OUTLET
8	ILLUMINATED PUSH BUTTON		SWITCHED DUPLEX OUTLET
6	DIMMER/FAN CONTROL		220V OUTLET
	SWITCHES GROUPED IN ONE PLATE	WP	WATERPROOF DUPLEX OUTLET
T	THERMOSTAT		QUADRAPLEX OUTLET
	RECESSED FLUORESCENT FIXTURE	H	CEILING LIGHT, VENT & HEATER
S	SMOKE DETECTOR	(V)	VENT
CO	CO DETECTOR	WP	WATERPROOF LIGHT FIXTURE

ELECTRIC NOTES

- 1. CONTRACTOR SHALL VERIFY ON SITE ALL CONDITIONS AND MEASUREMENTS SHOWN ON THE DRAWINGS.
- 2. WHEREVER THE INSTALLATION OF ELECTRICAL EQUIPMENT AS SHOWN ON THE DRAWINGS IS IMPRACTICAL FOR ANY REASONS, THE CONTRACTOR SHALL INSTALL THE EQUIPMENT AT NEW LOCATIONS IN ACCORDANCE TO CODE.
- 3. ALL BOLTS SHALL HAVE LOCK WASHERS AND ELASTIC STOP NUTS.
- 4. ALL CONDUITS SHALL BE SIZED IN ACCORDANCE WITH NATIONAL ELECTRICAL CODE.
- 5. ALL ELECTRICAL EQUIPMENT SHALL BE GROUNDED AS PER NATIONAL ELECTRICAL CODE AND THE SPECIFICATIONS. THE GROUND RESISTANCE SHALL NOT EXCEED 10 OHMS.
- 6. CONTRACTOR SHALL COORDINATE THE INSTALLATION OF LIGHTING FIXTURES, RECEPTACLES, DISCONNECT SWITCHES, AND SWITCHES WITH THE INSTALLATION OF OTHER EQUIPMENT.
- 7. ELECTRICAL WORK SHOWN AS CONCEALED OR FLUSH SHALL BE INSTALLED BY THE ELECTRICAL CONTRACTOR PRIOR TO POURING OF CONCRETE OR INSTALLATION OF OTHER EQUIPMENT OR MATERIALS.
- 8. LIGHTING CONTROL SWITCHES SHALL BE MOUNTED 4'0" O.C. & A.F.F. NEAR STRIKE PLATE OF DOOR REGARDLESS OF SWITCH POSITION SHOWN.
- 9. THE LAYOUTS SHOWN ON DRAWINGS ARE ONLY SCHEMATIC. CONTRACTOR SHALL SUBMIT FOR APPROVAL SHOP DRAWINGS SHOWING THE DETAILS OF THE METHOD OF INSTALLATION AND MOUNTING OF ALL PANELBOARDS, CABLE TROUGHS, INDOOR AND OUTDOOR LIGHTING FIXTURES, CONDUITS, AND CONDUIT RUNS TO PANELBOARDS.
- 10. ALL CONDUITS SHALL CONTAIN AN INDEPENDENT GROUND WIRE. WHETHER SPECIFICALLY SHOWN OR NOT ON THE INDIVIDUAL DRAWINGS. WIRES SHALL BE SIZED AS PER NATIONAL ELECTRICAL CODE REQUIREMENTS.
- 11. ALL 20 AMP RECEPTACLES SHALL HAVE A ONE-PIECE SOLID BRASS MOUNTING STRAP WITH INTEGRAL GROUND CONTACTS (NO RIVETS) TO ASSURE LOWEST RESISTANCE GROUNDING PATH.
- 12. LOCATION OF SWITCHES, BOXES, AND CONDUITS PROVIDING POWER FOR EQUIPMENT ARE APPROXIMATE, EXACT LOCATIONS ARE DEPENDENT UPON INSTALLATION OF EQUIPMENT.
- 13. ALL FIXTURES SHALL BE PROVIDED WITH ALL ACCESSORIES FOR A COMPLETE INSTALLATION. THESE INCLUDE MOUNTING ACCESSORIES.
- 14. ALL FLUORESCENT FIXTURES SHALL BE OF RAPID START TYPE WITH ELECTRONIC BALLASTS AND T-8 TYPE RAPID START LAMPS.
- 15. ALL SECURITY DEVICES ASSOCIATED WITH THE INTRUSION ALARM SYSTEM ARE SUPPLIED AND INSTALLED BY THE SECURITY CONTRACTOR.
- 16. A SEPARATE DEDICATED NEUTRAL WIRE SHALL BE PROVIDED AND INSTALLED FOR GFI RECEPTACLE CIRCUITS.
- 17. INSTALL FISH WIRE IN ALL EMPTY CONDUITS.
- 18. ALL RECEPTACLES MARKED ISOLATED GROUND TYPE SHALL HAVE AN ORANGE FACEPLATE AND BE ORANGE IN COLOR.



SENIUK RESIDENGE 528 TITAN STREET PHILADELPHIA, PA 1914

DATE:

10/15/2013

SCALE:

1/2" = 1'-0"

PROJECT: SENIUK
RESIDENCE


DRAWN BY: REVISION:

SRH 2.01

DRAWING TITLE:

ELECTRIC PLAN

DRAWING NUMBER:

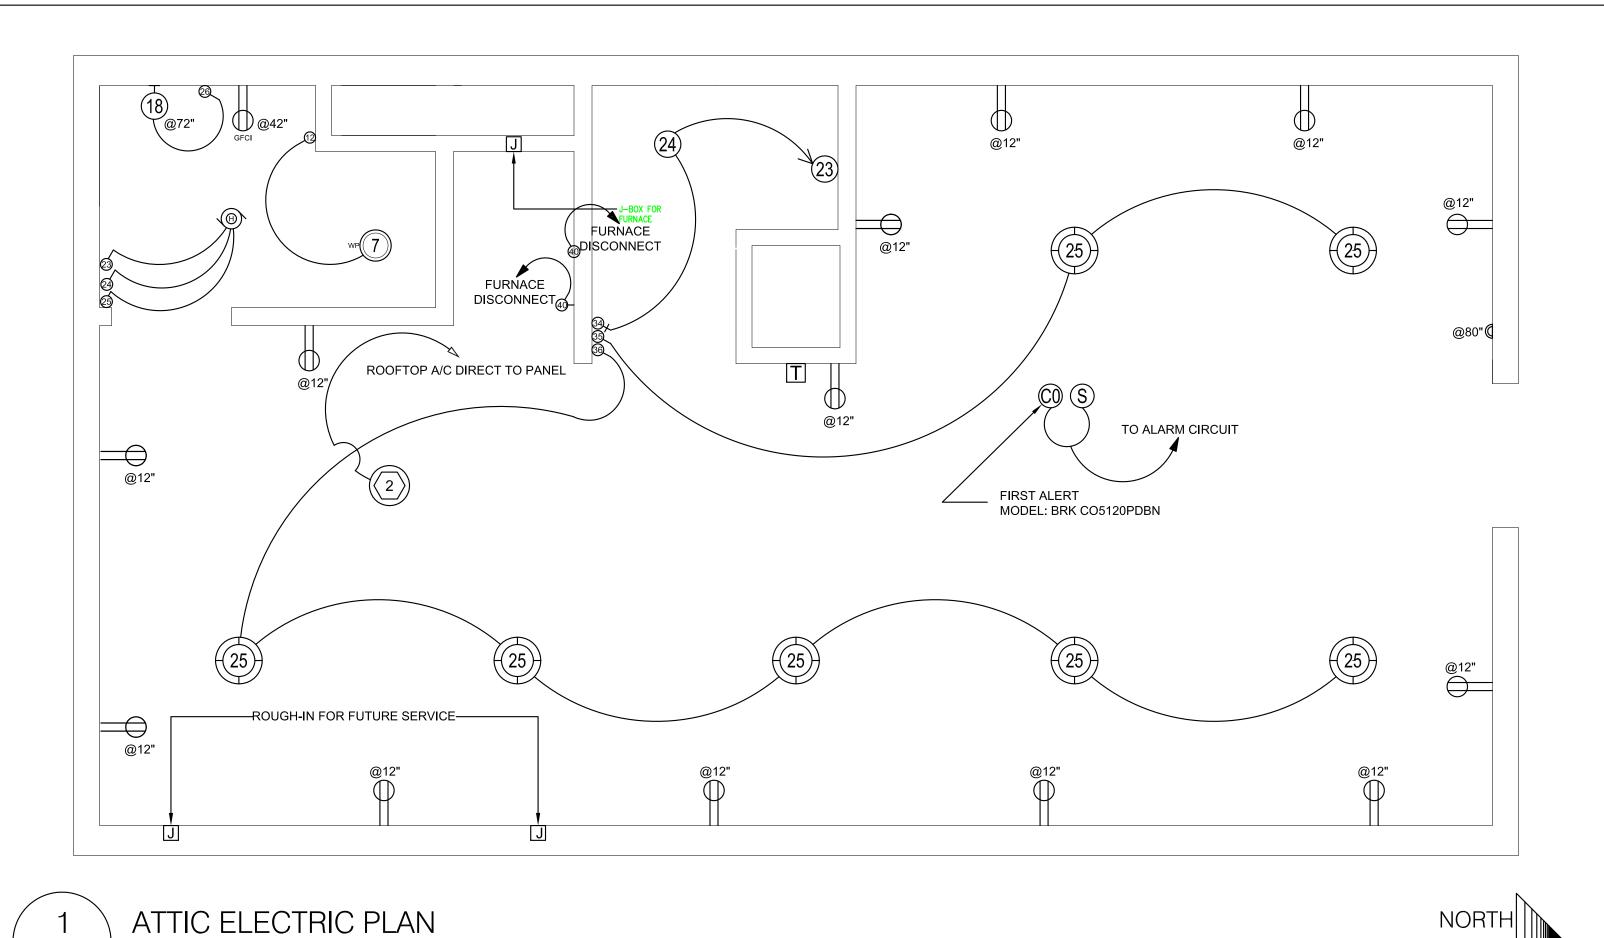

EQUIPMENT NOTES

THE CONTRACTOR SHALL FURNISH AND INSTALL A COMPLETE 24 VDC, ELECTRICALLY SUPERVISED, ANALOG ADDRESSABLE FIRE ALARM SYSTEM AS SPECIFIED HEREIN:

- 1. SYSTEM CABINET.
- 2. POWER SUPPLY.
- 3. ONE SLC LOOP, PLUS ONE OPTIONAL SLC LOOP.
- 4. 4 X 20 CHARACTER LCD ANNUNCIATOR.
- 5. DEDICATED LEDS DISPLAY'S FOR FIRE ALARM, GAS ALARM, TROUBLE.
- 6. PROGRAMMING KEYPAD.
- 7. UP TO 254 DETECTORS/PULL STATIONS/MODULES PLUS 254 ANALOG SOUNDER BASES ENDING UP TO A TOTAL OF 508 ADDRESSABLE POINTS.
- 8. BUILT IN DUAL LINE DIGITAL COMMUNICATOR.
- 9. BUILT IN WEB SERVER FOR IP COMMUNICATION FOR ALARM TRANSMITTING WITH FULL SINGLE, DOUBLE, AND BACKUP REPORTING AND PROGRAMMING.
- 10. ASSOCIATED PERIPHERAL DEVICES.
- 11. BATTERIES.
- 12. WIRING.
- 13. CONDUIT.

SMOKE DETECTOR SPECIFICATIONS

6 1/2"□DIAMETER X 2 5/8" H **DIMENSIONS:**

WEIGHT: 6 1/2 OUNCES WHITE PLASTIC **HOUSING:**

OPERATING TEMP RANGE: 40 TO 100 (# (4 TO 37 C)

THE SMOKE DETECTOR WITH BUILT-IN RELAY UTILIZES A PHOTOELECTRIC SENSING METHOD AND IS DESIGNED FOR USE IN COMMERCIAL AND RESIDENTIAL APPLICATIONS. THE DEVICE REQUIRES HARD.WIRED 120VAC 60HZ POWER (220VAC50 HZ OPTIONAL). THE DETECTOR FEATURES TWO SETS OF DRY ALARM CONTACTS: ONE FORM-A SPSTAND ONE FORM-C SPDT. THE DETECTOR HASTANDEM INTERCONNECT CAPABILITY ALLOWING UP TO 6 DEVICES TO BE CONNECTED TOGETHER. A 90DBA AUDIBLE HORN IS INCLUDED. ALSO AVAILABLE WITH

OPTIONAL BATTERY BACKUP OR IN 220V. SMOKE DETECTOR MODEL 120V W/BATTERY BACK-UP: FGD-0049-B

Access Lighting 11-in Brushed Steel Ceiling Flush Mount

E-1.1

SCALE: 1/2" = 1'-0"

LIGHTING FIXTURE SCHEDULE

NO.	DESCRIPTION	VOLT	MOUNTING	NO. & LAMP	REMARKS	NO.	DESCRIPTION	VOLT	MOUNTING	NO. & LAMP	REMARKS
1	ACGALAXY COACH LIGHT 14" RUBBED BRONZE MODEL: 350836ORB	120V-1PH	EXTERIOR WALL	(2) 100W	WATERPROOF COACH LIGHT	15	ACCESS LIGHTING 11" BRONZE CEILING FLUSH MOUNT CAT. 2064-B/OPL	120V-1PH	SURFACE	(1) 100W	
2	ACCESS LIGHTING 11" BRONZE CEILING FLUSH MOUNT CAT. 2064-B/OPL	120V-1PH	SURFACE	(1) 100W		16	THOMAS LIGHTING 7" WHITE WALL LIGHT MODEL: SL94358	120V-1PH	WALL	(1) 60W	
3	HALO 6" NEW CONSTRUCTION IC RECESSED LIGHTING MODEL:H7-ICT	120V-1PH	RECESSED	(1) 60W		17	LEGRANDE TITANIUM 9.97" LIGHT BAR MODEL: ALLNLEDTM4	120V-1PH	UNDER-CABINET	(3) 20W	
4	ACCESS LIGHTING 11" BRONZE CEILING FLUSH MOUNT CAT. 2064-B/OPL	120V-1PH	SURFACE	(1) 100W		18	GALAXY 3 LIGHT NEWPORT BRONZE BATH VANITY LIGHT MODEL: 712823B	120V-1PH	WALL	(1) 120W	VANITY LIGHT BAR - 3 X 40W
5	GOOD EARTH FLEXOLIGHT 12' CLEAR ROF LIGHT MODEL: G9512-CLR-1	PE 120V-1PH	SURFACE	(1) 15W	L.E.D. ROPE LIGHT	19	ACGALAXY COACH LIGHT 14" RUBBED BRONZE MODEL: 350836ORB	120V-1PH	EXTERIOR WALL	(1) 100W YELLOW BULB	WATERPROOF COACH LIGHT
6	THOMAS LIGHTING 7" WHITE WALL LIGHT MODEL: SL94358	120V-1PH	WALL	(1) 60W		20	ACCESS LIGHTING 11" BRONZE CEILING FLUSH MOUNT CAT. 2064-B/OPL	120V-1PH	SURFACE	(1) 100W	
7	RECESSED LIGHT TRIM FOR 6" HALO FIXTURE MODEL: Y721S	120V-1PH	RECESSED	(3) 60W	WATERPROOF SHOWER LIGHT W/LIGHT SPEC #3 FIXTURE	21	HALO 6" NEW CONSTRUCTION IC RECESSED LIGHTING MODEL:H7-ICT	120V-1PH	RECESSED	(1) 60W	
8	GALAXY 3 LIGHT NEWPORT BRONZE BATH VANITY LIGHT MODEL: 712823B	120V-1PH	WALL	(1) 120W	VANITY LIGHT BAR - 3 X 40W	22	ACCESS LIGHTING 11" BRONZE CEILING FLUSH MOUNT CAT. 2064-B/OPL	120V-1PH	SURFACE	(1) 100W	
9	ACGALAXY COACH LIGHT 14" RUBBED BRONZE MODEL: 350836ORB	120V-1PH	EXTERIOR WALL	(1) 100W YELLOW BULB	WATERPROOF COACH LIGHT	23	ACCESS LIGHTING 11" BRONZE CEILING FLUSH MOUNT CAT. 2064-B/OPL	120V-1PH	SURFACE	(1) 100W	
10	CHECKOLITE INTERNATIONAL 2 LIGHT BRONZED COUNTRY KITCHEN MODEL: P1002-71	120V-1PH	SURFACE	(1) 200W	HANGING KITCHEN LIGHT 2 X 100W BULBS	24	ACCESS LIGHTING 11" BRONZE CEILING FLUSH MOUNT CAT. 2064-B/OPL	120V-1PH	SURFACE	(1) 100W	
11	INTEGRAL HOOD LIGHT SEE MANUF. HOOD SPEC	120V-1PH	HOOD LIGHT	(1) 40W	40W HEAT RESISTANT LAMP	25	HALO 6" NEW CONSTRUCTION IC RECESSED LIGHTING MODEL:H7-ICT	120V-1PH	RECESSED	(7) 60W	
12	HALO 6" NEW CONSTRUCTION IC RECESSED LIGHTING MODEL:H7-ICT	120V-1PH	RECESSED	(1) 60W	OWNER TO SPECIFY TRIM FINISH	26	PORTFOLIO 3-LIGHT INTEGRATED LED TRACK MODEL: 18305-000	120V-1PH	SURFACE	(3) 60W	AREA TRACK LIGHTING
13	W SHANDY 4 1/2" 2 LIGHT BRONZE ARM WALL SCONCE MODEL: LW24240232	120V-1PH	WALL	(2) 60W		27	1'X4' FLUORESCENT PARABOLIC LITHONIA CAT. NO. PM3 G B 2 32 8ND 120 GEB	120V-1PH	SURFACE	(2) F32T8/TL735	RAPID START BALLAST
14	ACCESS LIGHTING 11" BRONZE CEILING FLUSH MOUNT CAT. 2064-B/OPL	120V-1PH	SURFACE	(1) 100W							





4 (P)


10/15/2013 1/2" = 1'-0"PROJECT: SENIUK RESIDENCE

> **REVISION:** 2.01

ELECTRIC PLAN

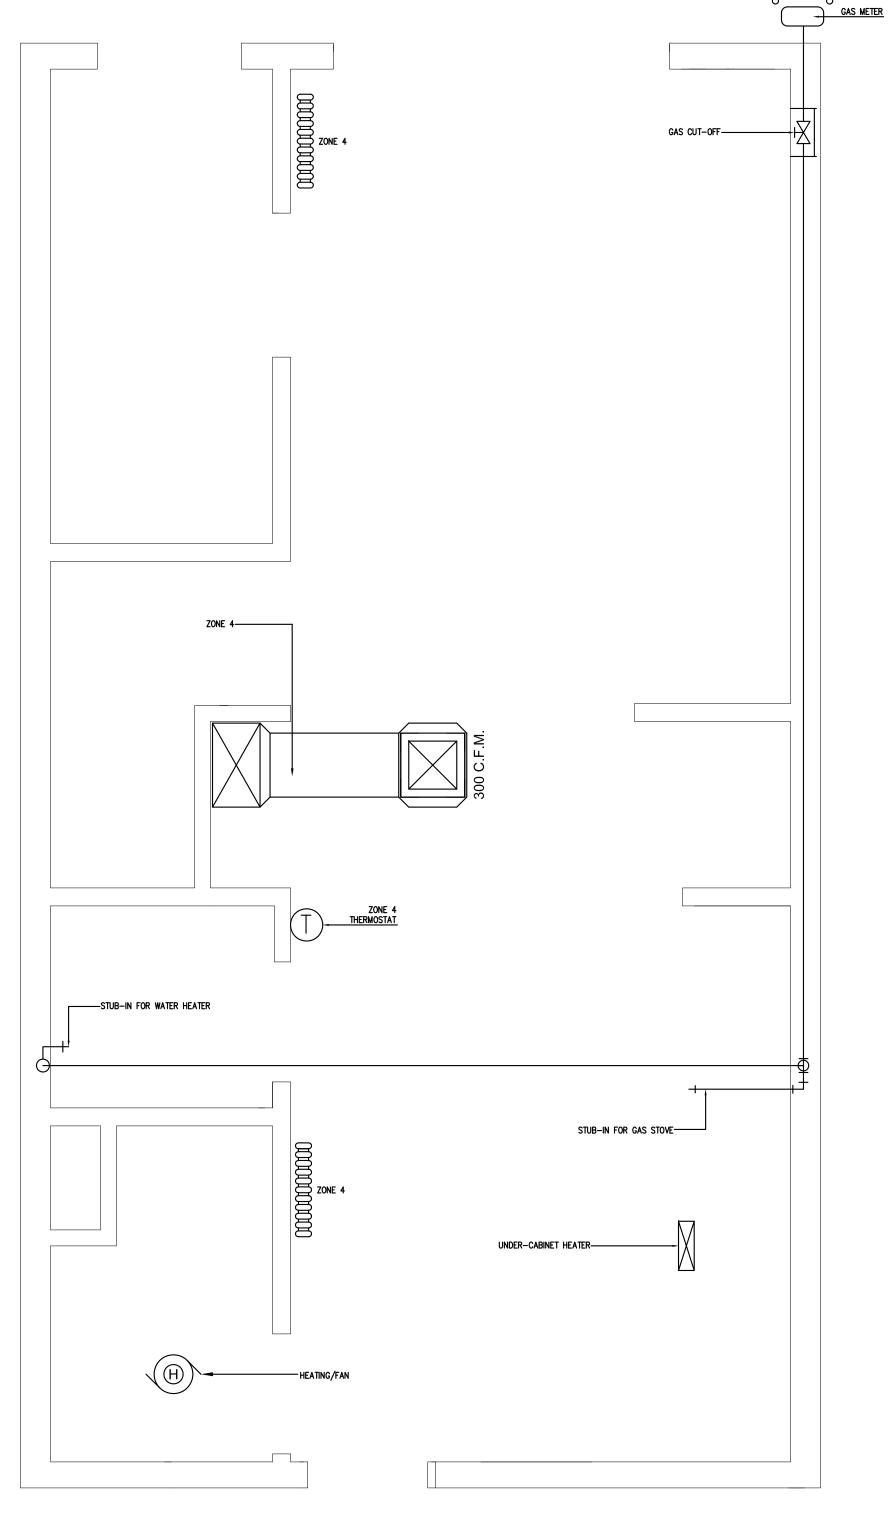

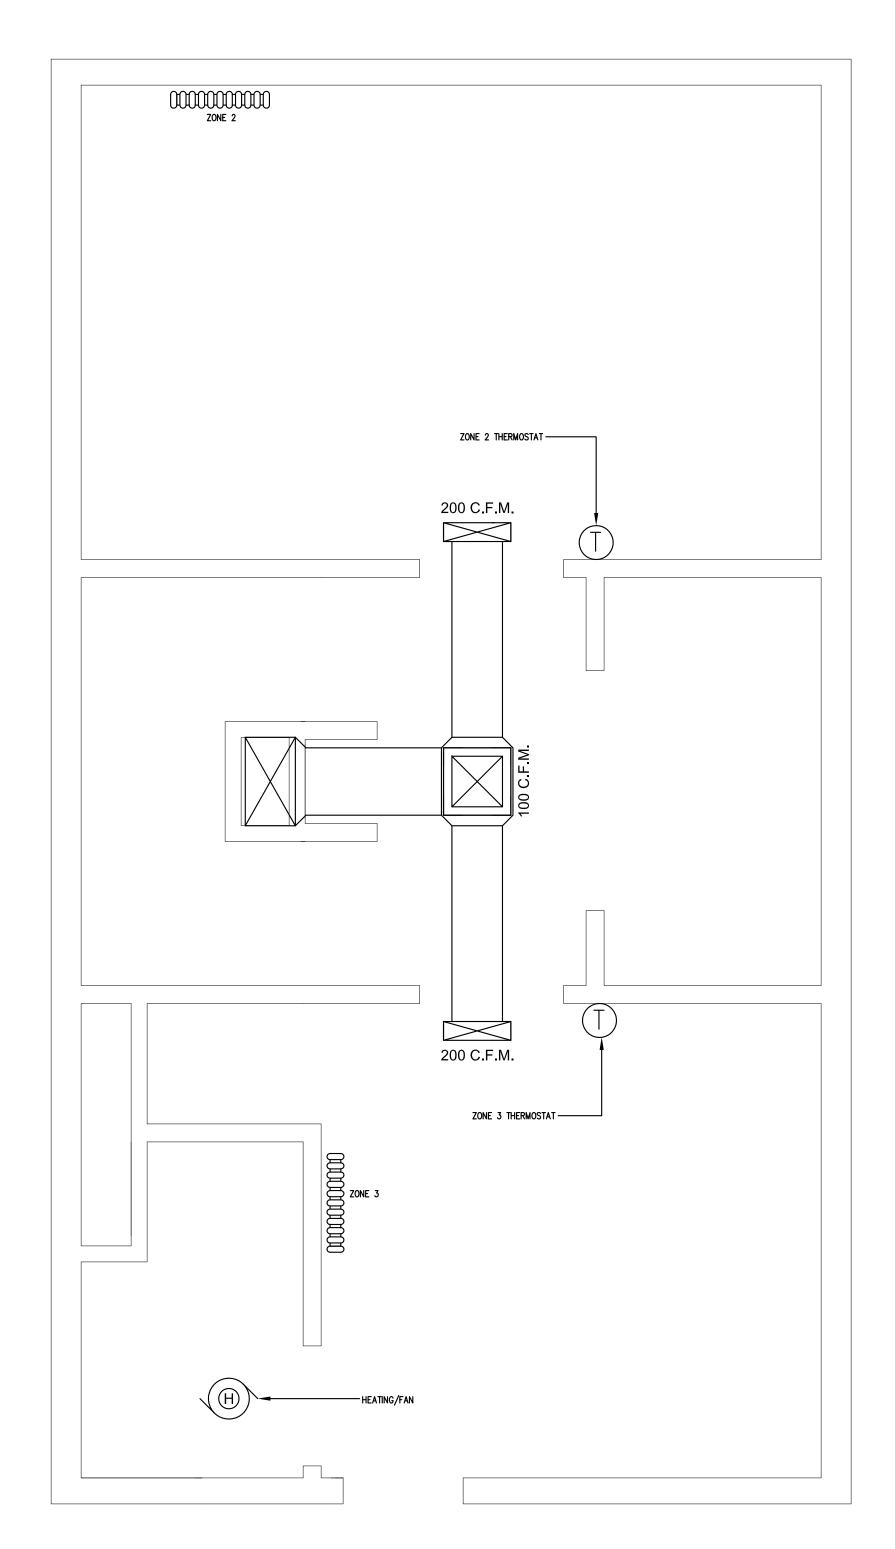

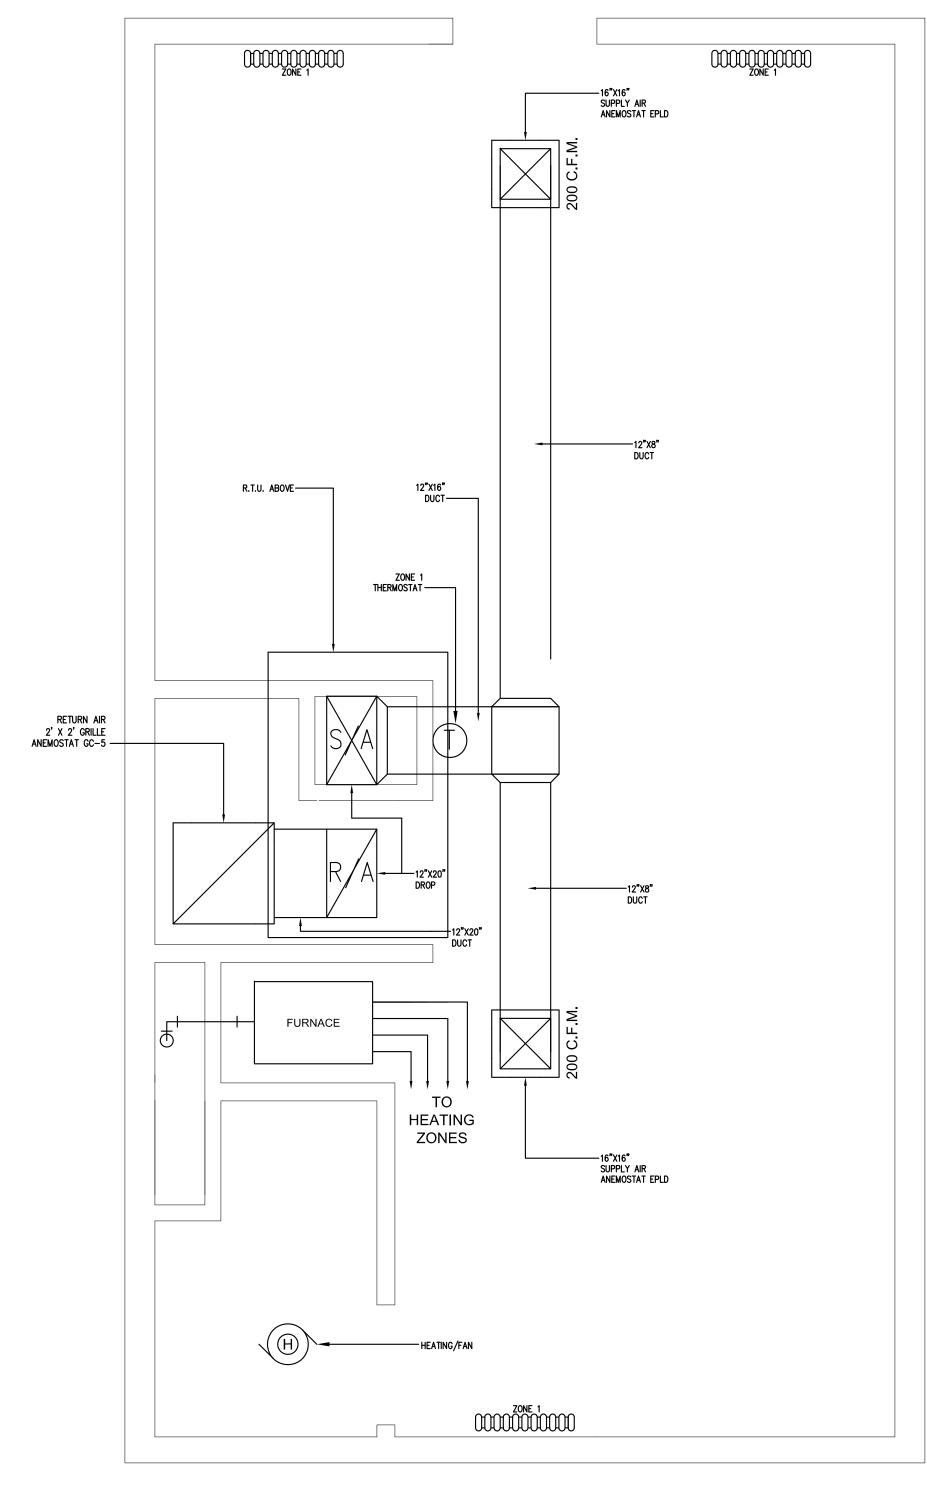

GROUND FLOOR HVAC PLAN \M-1.0/ SCALE: 1/2" = 1'-0"

MODEL: 350744

SECOND FLOOR HVAC PLAN

SCALE: 1/2" = 1'-0"

ATTIC HVAC PLAN M-1.0SCALE: 1/2" = 1'-0"

NOTES

SYSTEM, INCLUDING SPECIFICATIONS AND EFFICIENCY RATINGS ON RADIATORS

SPECIFICATIONS GAS RADIATOR SPECIFICATION **FURNACE SPECIFICATION** ROOFTOP UNIT SPECIFICATION UNDERCUT ALL ROOM ENTRY DOORS 1" TO ALLOW FOR RETURN AIR DRYER DUCT TO BE ROUTED HORIZONTALLY THROUGH KITCHEN SOFFIT WEIL-MCLAIN OR EQUIV. CARRIER WEATHER TECH OR EQUIV. MANUFACTURER: JOTUL ABOVE WALL CABINETS THROUGH OUTSIDE WALL MODEL: GF 100 BF **BOILER MODEL ULTRA-80** MODEL 50HJD004 BATH EXHAUST FANS TO BE ROUTED TO OUTSIDE AIR HEATING CAPACITY: 71,000 BTUH SINGLE PACKAGE ROOFTOP UNIT CATALOGUE NUMBER 350785 AVOID ANY DUCTWORK ABOVE ELECTRICAL PANEL CSA INPUT: 80,000 BTUH 3 TON NOMINAL 1200 CFM **HEAT OUTPUT: 3.7 KW** PROVIDE GRILL THROUGH WALL OF LAUNDRY ROOM FOR MAKE-UP AIR FOR HEAT INPUT: 4.6 KW CSA OUTPUT: 71,000 BTUH 36,000 BTUH NET COOLING ELECTRIC DRYER NET I=B=R RATINGS: 62,000 BTUH 3.21 KW 649# TOTAL WGHT. EFFICIENCY: 80% 6. PROVIDE FIBERBOARD BAFFLE BEHIND SUPPLY GRILL IN 2ND FLOOR ROOMS TO **BOILER WATER CONTENT: 0.69 GALLONS** FUEL EFFECT: COAL/LOG 208/230/1/60 **AVOID EXCESSIVE NOISE** GAS TYPE: NATURAL GAS DOE SEASONAL EFFICIENCY: 93.0% AFUE PROVIDE VARIABLE DAMPER IN SUPPLY DUCTWORK AS REQUIRED LOW TEMPERATURE SEASONAL FLUE OUTLET: REAR HVAC CONTRACTOR TO PROVIDE SHOP DRAWINGS FOR A/C AND BOILER THERMOSTATIC REMOTE CONTROL EFFICIENCY: 98.0%

VENT SIZE: 3"

\M-1.0/-

PHOTODESIGN.NET 732 SANSOM STREET PHILADELPHIA, PA 19106 215-629-0295 AGE QUOD AGIS

DATE: 10/15/2013 SCALE: N.T.S.

PROJECT: SENIUK

RESIDENCE **REVISION:** DRAWN BY:

SRH

MECHANICAL PLAN

2.01



PIPE SCHEDULES

- 1. VENT STACK PIPES TO BE SCHEDULE 40 PVC OR ABS
- 2. DRAIN LINES TO BE SCHEDULE 40 PVC OR ABS
- 3. WATER LINES TO BE NSF-PW & NSF-61 COMPATIBLE AND BE MADE OF COPPER, PEX OR CPVC

FIXTURE SCHEDULES

0)/14501	FIXTURE	MODEL	MOUNTING	CONNECTIONS				
SYMBOL	TYPE	MODEL	HEIGHT	CW	HW	WASTE	VENT	COMMENTS
WC1	WATER CLOSET	AMERICAN STANDARD CADET 3	FLOOR 12" OFF WALL	1/2"	-	4"	3"	1.28 GPF, PORCELAIN WHITE, ELONGATED SEAT, VITREOUS CHINA, MANUFACTURER'S MODEL NO. 3378.128ST.020
WC2	WATER CLOSET	AMERICAN STANDARD CADET 3	FLOOR 12" OFF WALL	1/2"	-	4"	3"	1.28 GPF, PORCELAIN WHITE, ELONGATED SEAT, VITREOUS CHINA, MANUFACTURER'S MODEL NO. 3378.128ST.020
WC3	WATER CLOSET	AMERICAN STANDARD CADET 3	FLOOR 12" OFF WALL	1/2"	-	4"	3"	1.28 GPF, PORCELAIN WHITE, ELONGATED SEAT, VITREOUS CHINA, MANUFACTURER'S MODEL NO. 3378.128ST.020
S1	KITCHEN SINK	VIGO UNDERMNT VG3019BK1	UNDER- COUNTER	1/2"	1/2"	2"	1-1/2"	UNDERMOUNT STAINLESS STEEL SINK W/ 3-1/2" DRAIN BASKET
SH1	SHOWER	MOEN ICON MOENTROL	78" A.F.F.	1/2"	1/2"	2"	1-1/2"	BRUSHED NICKEL, LEVER DESIGN, MODEL NO. TS2155BN
SH2	SHOWER	MOEN ICON MOENTROL	78" A.F.F.	1/2"	1/2"	2"	1-1/2"	BRUSHED NICKEL, LEVER DESIGN, MODEL NO. TS2155BN
SH3	SHOWER	MOEN ICON MOENTROL	78" A.F.F.	1/2"	1/2"	2"	1-1/2"	BRUSHED NICKEL, LEVER DESIGN, MODEL NO. TS2155BN
LAV1	LAVATORY	ZURN "ONE SYSTEM" NO. Z5311.261.1	34" A.F.F.	1/2"	1/2"	2"	1-1/2"	20" X 18" WHITE, WALL HUNG, ADA COMPLIANT, 4" CENTERSET FAUCET HOLES
LAV2	LAVATORY	ZURN "ONE SYSTEM" NO. Z5311.261.1	34" A.F.F.	1/2"	1/2"	2"	1-1/2"	20" X 18" WHITE, WALL HUNG, ADA COMPLIANT, 4" CENTERSET FAUCET HOLES
LAV3	LAVATORY	ZURN "ONE SYSTEM" NO. Z5311.261.1	34" A.F.F.	1/2"	1/2"	2"	1-1/2"	20" X 18" WHITE, WALL HUNG, ADA COMPLIANT, 4" CENTERSET FAUCET HOLES
W1	CLOTHES WASHER	WHIRLPOOL MODEL NO. LTE5243DQ	FLOOR	3/4"	3/4"	2"	2"	OATEY WASHING MACHINE OUTLET BOX W/ 3/4" BRASS MPT W/ 1/4 TURN

DOMESTIC WATER HEATER

SYMBOL	MANUFACTURER	MODEL	TANK CAPACITY GALLONS	INPUT RATING Btu / HR	RECOVERY RATE @100°F RISE	FLUE DIAMETER	COMMENTS
WH1)	A. O. SMITH	CYCLONE BTX-100	50	100,000	116	3" CPVC	GAS WATER HEATER, LOW NOx, BRASS DRAIN AND P & T VALVES, EXCEEDS NAECA REQUIREMENTS, 96% EFFICIENCY

NOTE:

SEE MECHANICAL AND HVAC PLANS FOR RADIATOR & BOILER SYSTEM LAYOUTS & SPECIFICATIONS

GENERAL PLUMBING NOTES

- A. COORDINATE EXACT LOCATION OF ROOF PENETRATIONS WITH ROOF STRUCTURE LOCATIONS.
- B. COORDINATE ALL PLUMBING AND PIPING WITH OTHER EQUIPMENT.
- C. INSTALL ALL MATERIALS IN ACCORDANCE WITH MANUFACTURERS RECOMMENDATIONS.
- D. SEE ARCHITECTURAL DRAWINGS FOR EXACT LOCATION AND INSTALLATION HEIGHT OF ALL PLUMBING FIXTURES & EXACT BUILDING DIMENSIONS.
- E. INSULATE ALL HOT WATER, COLD WATER AND P-TRAPS WITH TRAP WRAP.
- F. SEE SHEET P-1.1 FOR PLUMBING FIXTURE SCHEDULE.
- G. PROVIDE CHROME-PLATE STEEL ESCUTCHEONS FOR PIPES AT WALL PENETRATIONS.
- H. HOT AND COLD WATER RUNS ARE 3/4" UNLESS OTHERWISE SPECIFIED.
- I. ALL WATER RUNS ARE OVERHEAD AND SHALL BE CONCEALED WHERE EVER POSSIBLE. ANY EXPOSED PIPING SHALL BE COORDINATED WITH OWNER/BUILDER PRIOR TO INSTALLATION. SLOPE TO DRAIN.
- J. SEWER AND VENT RUNS ARE 3" UNLESS OTHERWISE SPECIFIED.
- K. HOT AND COLD WATER PIPING IS TO BE INSTALLED ACCORDING TO UPC. INSULATE HOT WATER AND COLD WATER SUPPLY PIPING UNDER
- 2" WITH R-4 FIBERGLASS INSULATION AND R-6 FOR PIPES ABOVE 2". L. CONTRACTOR RESPONSIBLE FOR LOCATING ALL UTILIT! LINES.
- M. ALL FLOOR DRAINS SHALL BE EQUIPPED WITH PROSET TRAP GUARD.
- N. ALL FIXTURES SHALL HAVE INDIVIDUAL CLEANOUTS.
- O. THE CONTRACTOR SHALL FIELD VERIFY ALL DIMENSIONS AND CONDITIONS OF EXISTING CONSTRUCTION AND REPORT ANY INCONSISTENCIES TO THE OWNER/BUILDER BEFORE PROCEEDING WITH WORK
- AFFECTED BY SUCH INCONSISTENCIES. THE CONTRACTOR IS RESPONSIBLE FOR OBTAINING THE INTENT OF THE DESIGN AS SHOWN ON THE PLANS. ACTUAL CONDITIONS SHALL GOVERN OVER WRITIEN DIMENSIONS, WRITIEN DIMENSIONS SHALL GOVERN OVER ACTUAL DRAWING REPRESENTATION.
- P. ALL WORK ON THIS PROJECT SHALL BE PERFORMED IN ACCORDANCE WITH APPLICABLE FEDERAL, STATE AND LOCAL LAWS, RULES AND REGULATIONS CONCERNING CONSTRUCTION SAFET!' AND HEALTH.
 Q. WATER LINES ON EXTERIOR WALLS SHALL BE ROUTED ON INTERIOR SIDE OF INSULATION.
- R. ALL POINTS-OF-CONNECTION SHOWN ON PLANS ARE APPROXIMATE. IT SHALL BE THE PLUMBING CONTRACTOR'S RESPONSIBILITY TO LOCATE ALL EXISTING PLUMBING LINES THAT ARE BEING CONNECTED TO.
- S. ALL VENTS THROUGH ROOF SHALL BE A MINIMUM OF 10'-0" FROM ANY MECHANICAL OR NATURAL FRESH AIR INTAKE.
- T. ALL MATERIALS LOCATED IN PLENUM AREAS OF BUILDING SHALL HAVE A FLAMESPREAD INDEX NOT GREATER THAN TWENTY-FIVE (25) AND A SMOKE DEVELOPED INDEX NOT GREATER THAN FIFTY (50), WHEN TESTED IN ACCORDANCE WITH NFPA 255.



SENIUK RESIDENGE 528 TITAN STREET PHILADELPHIA, PA 19147

DATE:

10/15/2013

SCALE:

1/4" = 1'-0"

PROJECT: SENIUK
RESIDENCE

DRAWN BY: REVISION:
SRH 2.01

DRAWING TITLE:
PLUMBING NOTES
& SCHEDULES

P-1.1